# Construction Practitioner's Guide To Reading Architectural Plans and Specifications

Presented By:

Aaron L. Boyette CGC, CBC, CCC
BoyetteZettle LLC


December 13, 2021




# Today's Agenda

Case Study: Care Point Health & Wellness Center

- Drawings (Plans)
- Specifications
- Order of Precedence
- Questions

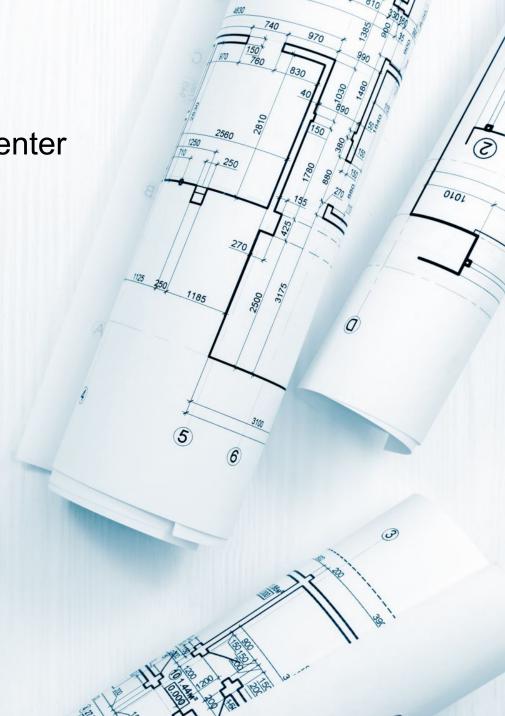

# Case Study - Care Point Health & Wellness

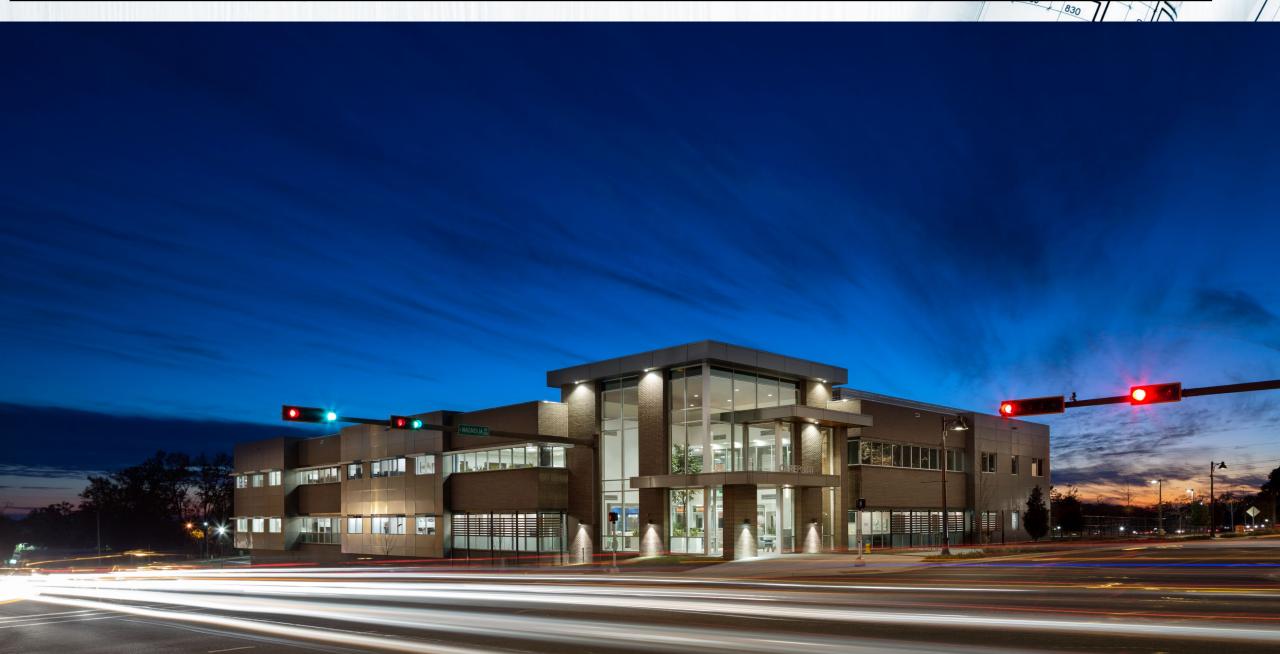



# **Drawings**

- What are Drawings?
- Drawing Types
- Cover Sheet
  - Project Name and Location
  - Design Phase Designation
  - Drawing Index (Plan Set Layout)
  - Applicable Codes
  - General Notes
  - Design Team
  - Title Block
- Architectural Plan Types
- Architectural Symbols
- Sections, Details and Schedules



# What Are Drawings?

· AIA A201 §1.1.5 defines Drawings (Plans) as...

 "Graphic and pictorial portions of the Contract Documents's showing the design, location and dimensions of the Work, general including plans, elevations, sections, details, schedules, and diagrams."

# **Drawing Types**

- · Civil (C)
- Life Safety (LS)
- Architectural (A)
- Structural (S)
- Mechanical (M)
- Fire Protection (FP)
- Plumbing (P)
- Electrical (E)




# **Cover Sheet**

- Project Name and Location
- Design Phase Designation
- Drawing Index (Plan Set Layout)
- Applicable Codes
- General Notes
- Design Team
- Title Block



# **COVER SHEET**

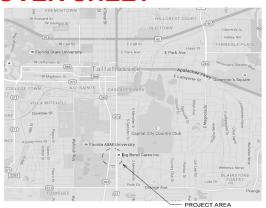

# **NEW PRIMARY CARE CLINIC**

**FOR** 

# **BIG BEND CARES**

2208 S. MONROE ST, TALLAHASSEE, FLORIDA

# 100% Construction Documents



# LOCATION MAP



CONTRACTOR TO FIELD VERIFY ALL DIMENSIONS AND FIELD CONDITIONS AT THE SITE PRIOR TO START OF CONSTRUCTION. IF NEEDED, NOTIFY ARCHITECT IN WRITIN OF ANY DISCREPANCIES OR DISCOVERED PROBLEMS. WRITTEN DIMENSIONS SHALL TAKE PRECEDENCE OVER SCALED DIMENSIONS.

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# Architect:

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Robin Winton, P.E. CxA

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# Interior Designer:

Catherine Baker SheltonDean, Inc SheltonDean Designs, LLC

Tallahassee, FL 32308 850.264.3559 catherine@sheltondean.com

CS0 1 COVER SHEET

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SEAL:

PROJECT TITLE:

Care Clinic 교 **Tallahassee**, Bend **New Primary** Sť,

Monroe JOB NO.: 14.106

DESIGNED: BUMI

Big

DRAWN BUMI CHECKED: BJ/ML

DRAWN/AS PHASE: 100% Construction

DRAWING TITLE:

COVER SHEET

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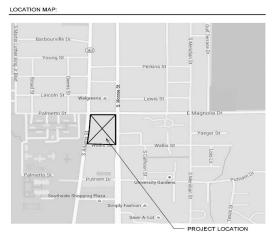


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PROJECT TITLE:

Care Clinic 교 St, Tallahassee, Bend **New Primary** Monroe Big

JOB NO.: 14.106 DESIGNED: BUMI DRAWN BUMI

CHECKED: BJ/MI

DRAWN/AS PHASE:

100% Construction

DRAWING TITLE:

COVER SHEET

SHEET NO.:

CS0.1

DATE: 6 November 2015




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CS0.1 COVER SHEET

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BACKINGGCONSTRUCTION DETAILS
UTILITY CENTER DETAIL

SEAL:

PROJECT TITLE:

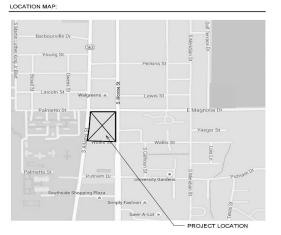New Primary Care Clinic 교 St, Tallahassee, Bend (

JOB NO.: 14.106 DESIGNED: BJ/ML DRAWN BUMI CHECKED: BJ/ML

Monroe Big

DRAWN/AS PHASE: 100% Construction

DRAWING TITLE:

COVER SHEET

SHEET NO.: CS0.1

DATE:

# **Applicable Codes**

# **NEW PRIMARY CARE CLINIC**

**FOR** 

# **BIG BEND CARES**

2208 S. MONROE ST, TALLAHASSEE, FLORIDA

100% Construction Documents

COVER SHEET COVER SHEEL
EXISTING CONDITIONS
TREE REMOVAL PLAN
DEMOLITION & EROSION CONTROL PLAN
SITE LAYOUT PLAN
TRAFFIC MOBILITY PLAN
GRADING AND DRAINAGE PLAN
UTILITY PLAN
LANDSCAPE PLAN
CONSTRUCTION DETAILS FIRST FLOOR LIFE SAFETY PLAN SECOND FLOOR LIFE SAFETY PLA

# APPLICABLE CODES:

THE SUBJECT PROJECT IS TO COMPLY WITH THE FOLLOWING COMPONENTS OF THE FLORIDA BUILDING CODE (FBC), FIFTH (2014) EDITION (UNLESS NOTED OTHERWISE).

FL BLDG CODE, BUILDING (FBC-B)

FL BLDG CODE, EXISTING BUILDING (FBC-EB)

FL BLDG CODE, ACCESSIBILITY (FBC-A)

FL BLDG CODE, ENERGY CONSERVATION (FBC- EC)

FL BLDG CODE, MECHANICAL (FBC-M)

FL BLDG CODE, FUEL GAS (FBC-FG)

FL BLDG CODE, PLUMBING (FBC-P)

FL FIRE PREVENTION CODE (FFPC), FIFTH EDITION

NATIONAL ELECTRICAL CODE (NEC 70), 2011 EDITION

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# Interior Designer:

Catherine Bake SheltonDean, Inc SheltonDean Designs, LLC 2001 Thomasville Road Tallahassee, FL 32308

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### LOCATION MAP



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COVER SHEET

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X1.3

pmckee@structuralsolutions.biz

# Mechanical and Plumbing

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FL BLDG CODE, ENERGY CONSERVATION (FBC-EC)
FL BLDG CODE, ENERGY CONSERVATION (FBC-EC)
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BACKING/CONSTRUCTION DETAILS
UTILITY CENTER DETAIL



SEAL

PROJECT TITLE:

Clinic 교 Tallahassee Cares Care Bend Primary

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Monroe Big New တ် JOB NO.: 14.106 DESIGNED: BUMI

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COVER SHEET

HEET NO.:

CS0.1

6 November 2015

DATE:



**FOR** 

# **BIG BEND CARES**

2208 S. MONROE ST, TALLAHASSEE, FLORIDA

# 100% Construction Documents

# PROJECT LOCATION

LOCATION MAP

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CS0 1 COVER SHEET

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UTILITY CENTER DETAIL

SEAL:

PROJECT TITLE:

New Primary Care Clinic 교 St, Tallahassee, Bend (

Monroe Big

JOB NO.: 14.106 DESIGNED: BJ/ML

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DRAWN/AS PHASE: 100% Construction


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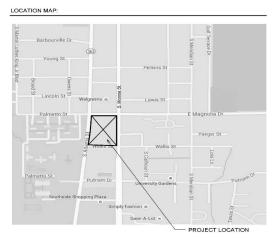


**FOR** 

# **BIG BEND CARES**

2208 S. MONROE ST, TALLAHASSEE, FLORIDA

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CS0 1 COVER SHEET

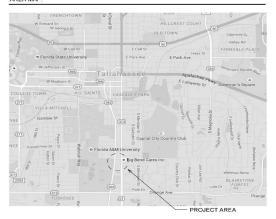INTERIOR ELEVATIONS
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UTILITY CENTER DETAIL

SEAL:

PROJECT TITLE:

New Primary Care Clinic 교 St, Tallahassee, **Bend Cares** 

Monroe JOB NO.: 14.106

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DESIGNED: BJ/ML DRAWN BUMI CHECKED: BJ/MI



DRAWN/AS PHASE: 100% Construction

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**FOR** 

# **BIG BEND CARES**

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LOCATION MAP



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SEAL:

PROJECT TITLE:

Clinic Tallahassee Care Bend Primary

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JOB NO.: 14.106 DESIGNED: BUMI DRAWN BIMI

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SHEET NO.:

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SEAL:

PROJECT TITLE:

Clinic ш Tallahassee, are Bend **Primary** Big



# **NEW PR**

# **Architect / Engineer**

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# **Project Name and** Location

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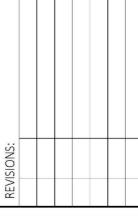
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SHEET NO .:

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DATE:

6 November 2015

Arch. / Eng. Job Number, Designer, **Checked By.** 

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Revisions



# **Drawing Phase**



**Drawing Title** 

# **Sheet Number**

ee@structuralsolutions hiz

Date (Typically Original Publish Date)

ahassee, FL 32308 0.264.3559

THE SUBJECT PROJECT IS TO COMPLY WITH THE FOLLOWING COMPONENTS OF THE FLORIDA BUILDING CODE (FBC), FIFTH (2014) EDITION (UNLESS NOTED

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SEAL:

PROJECT TITLE:

**New Primary Care Clinic** 


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COVER SHEET

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# LOCATION MAP



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THE CONTRACTOR SHALL BE RESPONSIBLE FOR FINAL APPROVAL OF ALL FINISH MATERIAL SELECTIONS PER THE OWNER'S REQUEST.

3. THE CONTRACTOR ASSUMES ALL RESPONSIBILITY FOR THE MATERIALS AND METHODS OF CONSTRUCTION USED FOR THIS PROJECT.
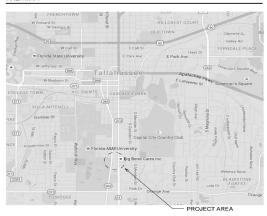
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# **NEW PR**

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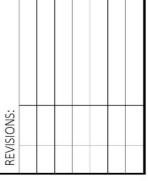
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SHEET NO .:

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DATE:

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# ocuments

# Revisions



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### DRAWING INDEX:

CS0.1 COVER SHEET

**REVISIONS:** 12/18/15 Addendum No. 1

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SECOND FLOOR FRAMING PLAN
ROOF FRAMING PLAN
HIGH ROOF FRAMING PLAN AND DETAILS
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FLOOR PLAN
CONSTRUCTION PLAN
ELECTRICAL PLAN
ELECTRICAL LOW YOLTAGE PLAN
PLUMBING PLAN DENTAL
BACKING/CONSTRUCTION DETAILS
UTILITY CENTER DETAIL

SEAL:

PROJECT TITLE:

Clinic Monroe St, Tallahassee, Care Bend **New Primary** Big

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JOB NO.: 14.106 DESIGNED: BUMI DRAWN BIMI CHECKED: BJ/ML

DRAWNIAS PHASE: 100% Construction

DRAWING TITLE:

COVER SHEET

SHEET NO.:


CS0.1

DATE: 6 November 2015


# **Architectural Plan Types**

- Plan (Birdseye View)
- Elevations
- Sections (Building / Wall)
- Details
- Schedules




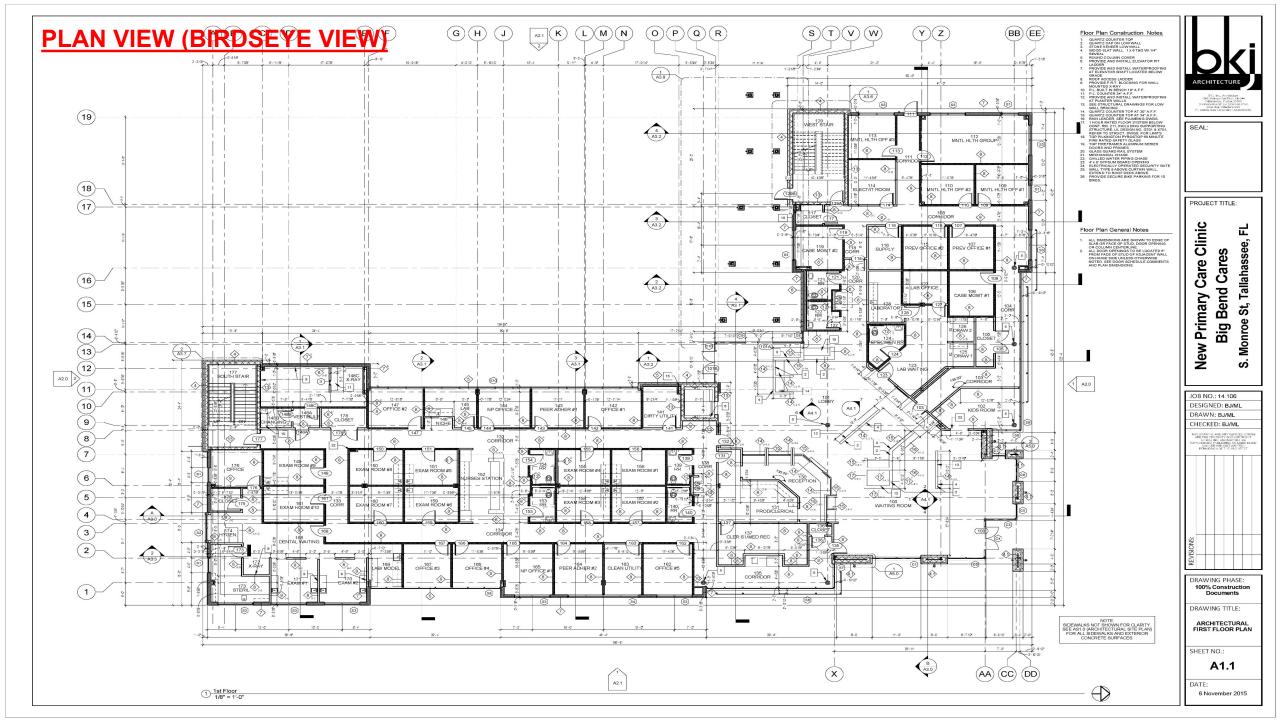

# **ELEVATIONS**

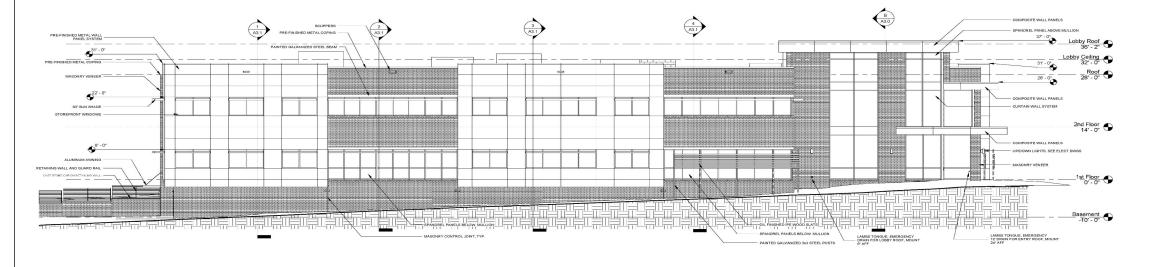

1/8" = 1'-0"

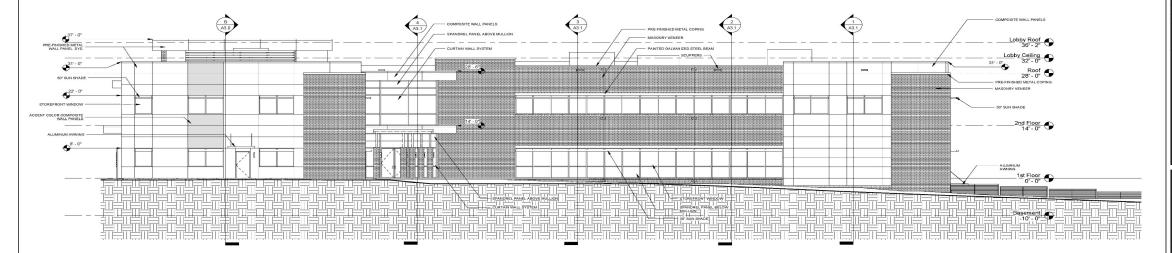

SEAL:

PROJECT TITLE:

New Primary Care Clinic 교 S. Monroe St, Tallahassee, Big Bend Cares

JOB NO.: 14.106 DESIGNED: BJ/ML

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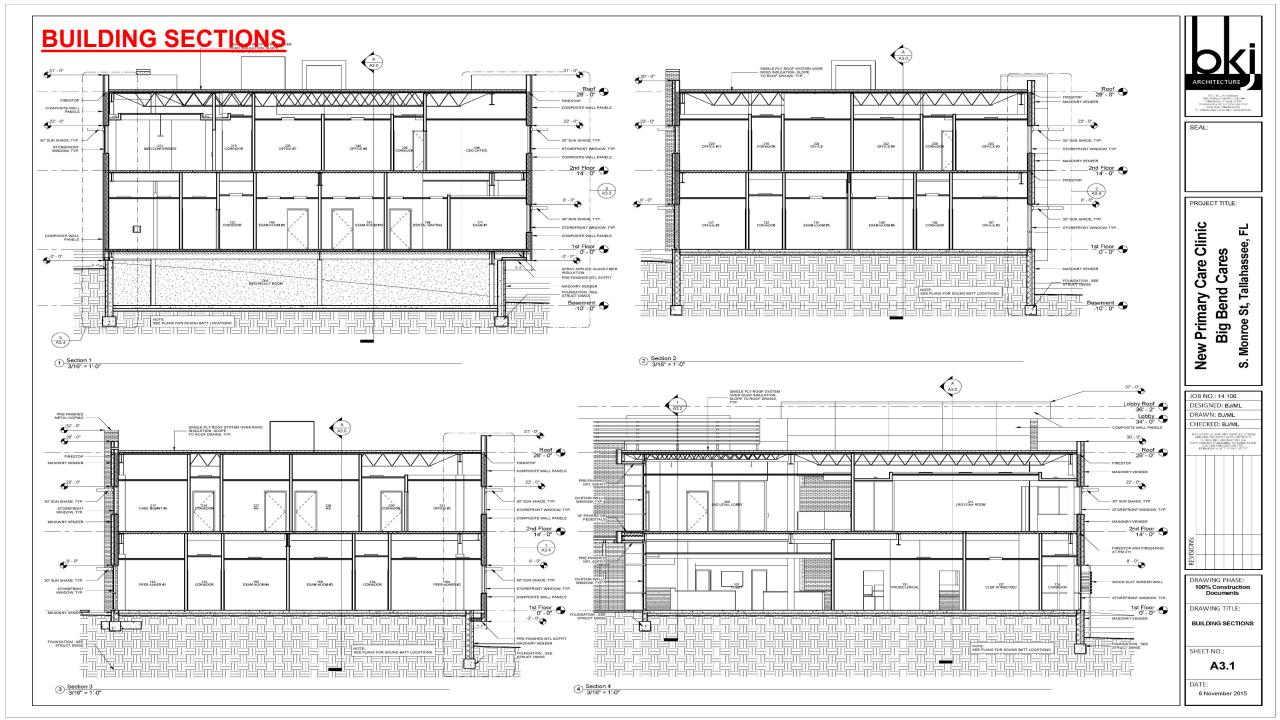
BUILDING ELEVATIONS


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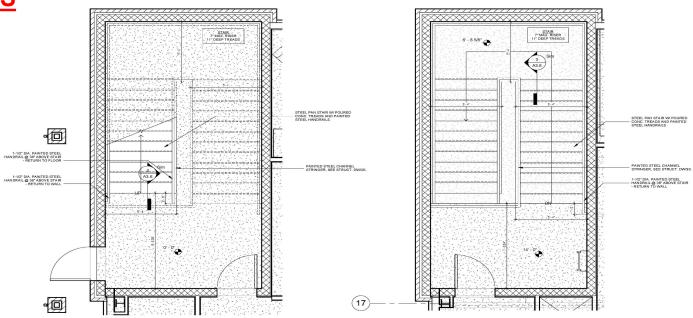
DATE: 6 November 2015

West Elevation
1/8" = 1'-0"









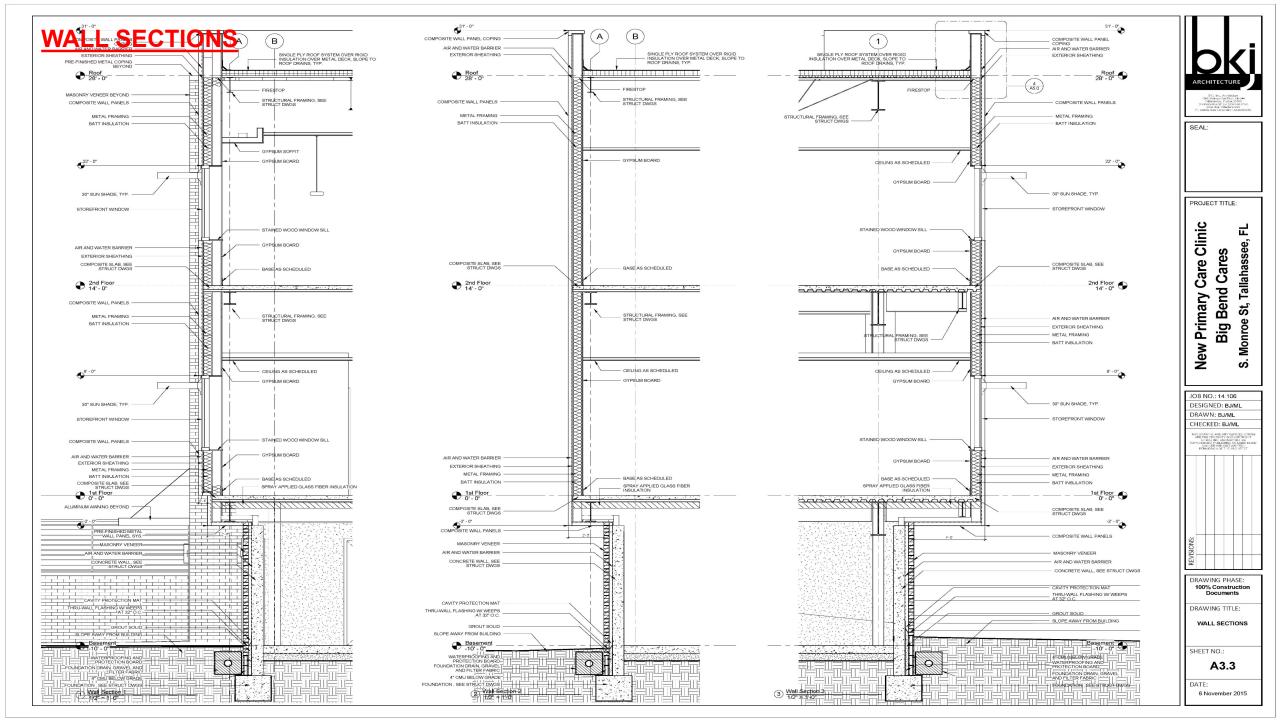

1 Enlarged Plan - 1st Floor West Stair 3/8" = 1'-0"

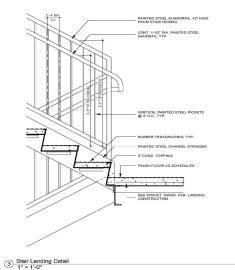

2 Enlarged Plan - 2nd Floor West Stair 3/8" = 1'-0"

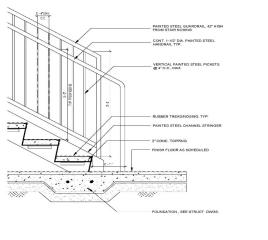

4 Stair Detail
1" = 1'-0"



PROJECT TITLE:

교 S. Monroe St, Tallahassee,

New Primary Care Clinic **Big Bend Cares** 

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DRAWING TITLE: STAIR DETAILS

SHEET NO.:

A3.6

DATE: 6 November 2015

	ROOM DESCRIPTION	FINISH	NORTH	WALLS	SOUTH	WEST	NOTES	BASE	CEILING FINISH	SOFFIT	FLOOR FLOOR FINISH	NOTES
001	MECH/ELECT ROOM	PAINT	PT.1	PT.1	PT.1	PT.1		VC 1			SEALED CONCRETE	
002 RST FI	SOUTH STAIR	PAINT	PT.2	PT.2	PT.2	PT.2		VC 1	PT.2		RB 1	
	WAITING ROOM	PAINT, STONE, WOOD	SEE FINISH PLAN	SEE FINISH PLAN	SEE FINISH PLAN	SEE FINISH PLAN		VC 1	WD 1	WD 1	CPT 1, LVT 1, TL 1	SEE FINISH PLA
101	LOBBY	PAINT, STONE, WOOD	SEE FINISH PLAN		SEE FINISH PLAN			VC 1	ACT 1	PT.3/PT.5	CPT 1, LVT 1, TL 1	SEE FINISH PLA
102	KIDS ROOM	PAINT	PT.3	PT.3	PT.3	PT.3		VC 1	ACT 2		CPT 1	
103	CORRIDOR	PAINT	PT.2	PT.2	PT.2	PT.2		VC 1	ACT 1		LVT 1	
104	CORR	PAINT	PT.2	PT.2	PT.2	PT.2		VC 1	ACT 1		LVT 1	
105	CLOSET	PAINT	PT.1	PT.1	PT.1	PT.1		VC 1	ACT 2		LVT 1	
106	CASE VIGMT N1	PAINT	PT.7	PT.7	PT.7	PT.7		VC 1	ACT 2	_	CPT 2	
107	PREV OFFICE #1	PAINT PAINT	PT.7	PT.7	PT.7 PT.2	PT.7 PT 2		VC 1	ACT 2	_	CPT 2	
108	CORRIDOR	PAINT	PT.2 PT 8	PT.2	P1.2 PT 8	PT.2 DT 8			ACT 1		LVT 1	
109	MINTL HLTH OFF #1	PAINT	P1.8	PT.8 PT.8	P1.8	P1.8		VC 1	ACT 2	_	CPT 2	
110	MINTL HLTH OFF #2 CORRIDOR	PAINT	PT.2	PT.2	PT.2	PT.2		VC 1	ACT 1	-	LVT 1	
1112	MINTL HLTH GROUP	PAINT	PT.2	PT.9	PT.9	PT.9		VC 1	ACT 2	_	CPT 2	
112	MINTL HUTH GROUP	PAINT	PT.8	PT.8	PT.8	PT.8		VC 1	ACT 2	_	CPT 2	
114	ELECTAT ROOM	PAINT	PT.1	PT.1	PT.1	PT.1		VC 1	ACT 2	_	LVT 1	
115	PREV OFFICE #2	PAINT	PT7	PT 7	PT 7	PT 7		VC 1	ACT 2	_	CPT 2	
116	SUPPLY	PAINT	PT.1	PT.1	PT.1	PT.1		VC 1	ACT 2	_	LVT 1	
117	CLOSET	PAINT	PT.1	PT.1	PT.1	PT.1		VC 1	ACT 2	_	LVT 1	
118	CORR	PAINT	PT.2	PT.2	PT.2	PT.2		VC 1	ACT 1	_	LVT 1	
119	CASE VIGMT#2	PAINT	PT.7	PT.7	PT.7	PT.7		VC 1	ACT 2		CPT 2	
120	CORR	PAINT	PT.1	PT.1	PT.1	PT.1		VC 1	ACT 1		LVT 1	
	RR	PAINT	PT.3	PT.3	PT.3	PT.3		VC 1	ACT 2		TL1	
122	RR	PAINT	PT.3	PT.3	PT.3	PT.3		VC 1	ACT 2		TL 1	
123	LAB WAITING	PAINT	PT.2	PT.2	PT.2	PT.2		VC 1	ACT 2		LVT 1	
124	SPECIVAN RR	PAINT	PT.2	PT.2	PT.2	PT.2		VC 1	ACT 2		TL1	
125	DRAW 1	PAINT	PT.2	PT.2	PT.2	PT.2		VC 1	ACT 2		LVT 2	
126	DRAW 2	PAINT	PT.2	PT.2	PT.2	PT.2		VC 1	ACT 2		LVT 2	
127	LAB OFFICE	PAINT	PT.7	PT.7	PT.7	PT.7		VC 1	ACT 2	_	CPT 2	
128	LABORATORY	PAINT	PT.2	PT.2	PT.2	PT.2		VC 1	ACT 2		LVT 1	
129	WEST STAIR	PAINT	PT.2	PT.2	PT.2	PT.2		VC 1	PT.2		RB 1, RB 2	
130	RECEPTION	PAINT	SEE FINISH PLAN	SEE FINISH PLAN	SEE FINISH PLAN			VC 1	PT.5	PT.5	CPT 2	
131	PRODXCLERICAL	PAINT PAINT	PT.2 PT.1	PT.2	PT.2 PT.1	PT.2 PT.1		VC 1 VC 1	ACT 2	-	CPT 2 CPT 2	
132	CORRIDOR	PAINT	PT3	P1.3	PT.1	PT.1			ACT 1	_	LVT 1	
133	CORRIDOR	PAINT	PT.1	PT.1	P1.1	P1.1		VC 1	ACT1	_	LVT1	
135	CORRIDOR	PAINT	PT.1	PT.1	P1.1	PT.1		VC 1	ACT 1	_	LVT 1	
136	CLOSET	PAINT	PT.1	PT.1	PT.1	PT.1		VC 1	ACT 2	_	LVT 1	
137	CLER STIMED REC	PAINT	PT 2	PT.2	PT.2	PT.2		VC 1	ACT 2	_	CPT 2	
138	CORR	PAINT	PT.1	PT.1	PT.3	PT.1		VC 1	ACT 1	_	LVT1	
139	RR	PAINT	PT 3	PT 3	PT 3	PT 3		VC 1	ACT 2	_	LVT 2	
	RR	PAINT	PT3	PT.3	PT 3	PT3		VC 1	ACT 2	_	LVT 2	
141	DIRTY UTILITY	PAINT	PT.1	PT.1	PT.1	PT.1		VC 1	ACT 2	_	LVT 1	
142	OFFICE #1	PAINT	PT.4	PT.4	PT.1	PT.1		VC 1	ACT 2		CPT 2	
143	PEER ADHER #1	PAINT	PT.8	PT.8	PT.8	PT.8		VC 1	ACT 2		CPT 2	
144	NP OFFICE #2	PAINT	PT.4	PT.4	PT.1	PT.1		VC 1	ACT 2		CPT 2	
145	LAB	PAINT	PT.2	PT.2	PT.2	PT.2		VC 1	ACT 2		LVT 1	
146	NICHE	PAINT	PT.3	PT.3	PT.3	PT.3		VC 1	PT.1		LVT 1	
147	OFFICE #2	PAINT	PT.1	PT.1	PT.4	PT.4		VC 1	ACT 2		CPT 2	
148A	VESTIBULE	PAINT	PT.8	PT.8	PT.8	PT.8		VC 1	ACT 2		LVT 1	
1488	CHANGING	PAINT	PT.8	PT.8	PT.8	PT.8		VC 1	ACT 2	_	LVT 1	
149C	X-RAY	PAINT	PT.8	PT.8	PT.8	PT.8	PT OF HORIZONTAL	VC 1	ACT 2	_	LVT 1	
149	EXAM ROOM #9	PAINT	PT.1, PT.7	PT.1, PT.7	PT.1, PT.7	PT.1, PT.7		VC 1	ACT 2		LVT 1	
150	EXAM ROOM 48	PAINT	PT.1, PT.7	PT.1, PT.7	PT.1, PT.7	PT.1. PT.7	PT 1 4F HOR ZONTAL STRPE AT INT APP	VC 1	ACT 2		LVT 1	
										_		
151	EXAM ROOM #5	PAINT	PT.1, PT.7	PT.1, PT.7	PT.1, PT.7	PT.1, PT.7	STREET AT NO AFF	VC 1	ACT 2		LVT 1	
152	NURSES STATION	PAINT, WD 1 PAINT	PT.3 PT.3	PT.1 PT.3	WD 1,PT.3 PT.3	PT.1 PT.3		VC 1	ACT 1	_	LVT 2	
153 154	RR RR	PAINT	P1.3 PT.3	PT.3 PT.3	PT.3	PT.3		VC 1	ACT 2	_	LVT 2 LVT 2	
_							PT : BET HOR TOKTAL STREET AT SIT ACT			_		
155	EXAM ROOM #4	PAINT	PT.1, PT.7	PT.1, PT.7	PT.1, PT.7	PT.1, PT.7		VC 1	ACT 2		LVT 1	
156	EXAM ROOM ₹1	PAINT	PT.1, PT.7	PT.1, PT.7	PT.1, PT.7	PT.1, PT.7	STREE AT STAFF	VC 1	ACT 2		LVT 1	
157	EXAM ROOM #2	PAINT	PT.1, PT.7	PT.1, PT.7	PT.1, PT.7	PT.1. PT.7		VC 1	ACT 2		LVT 1	
							STIETE AT 80" APP			_		
158	EXAM ROOM #3	PAINT	PT.1, PT.7	PT.1, PT.7	PT.1, PT.7	PT.1, PT.7		VC 1	ACT 2		LVT 1	
159	EXAM ROOM #8	PAINT	PT.1, PT.7	PT.1, PT.7	PT.1, PT.7	PT.1, PT.7	PT 1 48 HORIZONTAL STRIPE AT 34" ACT	VC 1	ACT 2		LVT 1	
160	EXAM ROOM #/	PAINT	PT.1, PT.7	PT.1, PT.7	PT.1. PT.7	PT.1. PT.7	STREET AT 36" AFF	VC 1	ACT 2		LVT 1	
_			,				PT T REP HORIZONTAL			_		
161	EXAM ROOM #10	PAINT	PT.1, PT.7	PT.1, PT.7	PT.1, PT.7	PT.1, PT.7	STREE AT SITARY	VC 1	ACT 2		LVT 1	
162	OFFICE #5	PAINT	PT.1	PT.4	PT.4	PT.1		VC 1	ACT 2	_	CPT 2	
163	CLEAN UTILITY	PAINT	PT.1	PT.1	PT.1	PT.1		VC 1	ACT 2	_	LVT 1	
164	PEER ADHER #2	PAINT	PT.8	PT.8	PT.8	PT.8		VC 1	ACT 2	_	CPT 2	
165	NP OFFICE #1	PAINT	PT.4	PT.4	PT.1	PT.1		VC 1	ACT 2	_	CPT 2	
166		PAINT	PT.4 PT.1	PT.4	PT.1	PT.1		VC 1	ACT 2	-	CPT 2	
167	OFFICE #3 DENTAL WAITING	PAINT	SEE FINISH PLAN		SEE FINISH PLAN			VC 1	ACT 2	_	CPT 2 CPT 1	
168	LAB/ MODEL	PAINT	PT.1	SEE FINISH PLAN	SEE FINISH PLAN	PT.1		VC 1	ACT 2	_	LVT 1	
170	EXAM #2	PAINT	SEE FINISH PLAN		SEE FINISH PLAN			VC 1	ACT 2	_	LVT1	
170	EXAM KI	PAINI	GEE EINIGH PLAN	SEE FINISH PLAN	SEE FINION FLAN	SEE FINISH PLAN		VC 1	ACT 2	_	LVIII	
172	X-RAY	PAINT	SEE FINISH PLAN	SEE EINIGH DI AN	SEE FINISH PLAN	SEE FINISH PLAN		VC 1	ACT 2	_	CPT 1	
173	STERIL.	PAINT	PT.7	PT.7	PT 7	PT.7		VC 1	ACT 2	_	LVT 1	
174	HYGEN.	PAINT	PT.1	PT.1	PT.1	PT.1		VC 1	ACT 2	_	CPT 1	
175	CLOSET	PAINT	PT 1	PT 1	PT.1	PT 1		VC 1	ACT 2	_	CPT 1	
176	OFFICE	PAINT	PT.7	PT.7	PT.7	PT7		VC 1	ACT 2	_	CPT 2	
177	SOUTH STAIR	PAINT	PT.2	PT.2	PT 2	PT.2		VC 1	PT.2	_	RB 1 RB 2	
		PAINT	PT.1	PT.1	PT.1	PT.1		VC 1	ACT 2	_	LVT 1	

				WALLS				1			FLOOR	ING
	ROOM DESCRIPTION	FINISH	NORTH	EAST	SOUTH	WEST	NOTES	BASE	CEILING FINISH	SOFFIT	FLOOR FINISH	NOTES
SECOND												
	2ND LEVEL LOBBY	PAINT, STONE, WOOD						VC 1	ACT 1	PT.7	CPT 1, LVT 1	
	WAITING	PAINT	PT.2	PT.2	PT.2	PT.2		VC 1	ACT 1		CPT 1, LVT 1, LVT 2	
	PHARMACY	PAINT	PT.2	PT.2	PT.2	PT.2		VC 1	ACT 2		LVT 1	
201C	PHAR, T	PAINT	PT.1	PT.1	PT.1	PT.1		VC 1	ACT 2		LVT 1	
202	PEER ADHER #2	PAINT	PT.8	PT.8	PT.8	PT.8		VC 1	ACT 2		CPT 2	
204	JANITOR	PAINT	PT.1	PT.1	PT.1	PT.1		VC 1	ACT 2		LVT 1	
205	CORRIDOR	PAINT	PT.1	PT.1	PT.1	PT.1		VC 1	ACT 1		LVT 1	
206	RR	PAINT	PT.3	PT.3	PT.3	PT.3		VC 1	ACT 2		LVT 2	
207	RR	PAINT	PT.3	PT.3	PT.3	PT.3		VC 1	ACT 2		LVT 2	
208	OPEN OFFICE	PAINT	PT.2	PT.2	PT.2	PT.2		VC1	ACT 2		CPT2	
209	RR	PAINT	PT.3	PT.3	PT.3	PT3		VC 1	ACT 2		LVT 2	
210	WEST STAIR	PAINT	PT.3	PT.3	PT.3	PT.3		VC 1	PT.2		RB 1, RB 2	
211	LRG CONF ROOM	PAINT	SEE FINISH PLAN	SEE FINISH PLAN	SEE FINISH PLAN	SEE FINISH PLAN		VC 1	ACT 1	PT.7	CPT 1	
212	ADMIN ENTRY	PAINT	PT.2	PT.2	PT.2	PT.2		VC 1	ACT 1		LVT 1	
213	ELECT. CLOSET	PAINT	PT.1	PT.1	PT.1	PT.1		VC 1	ACT 2		LVT 1	
214	CHAIR	PAINT	PT.1	PT.1	PT.1	PT.1		VC 1	ACT 2		CPT 1	
215	CORRIDOR	PAINT	PT.2	PT.2	PT.2	PT2		VC 1	ACT 1		LVT 1	
216	CASE MGMNT #3	PAINT	PT.1	PT.1	PT.4	PT4		VC 1	ACT 2		CPT 2	
217	CASE MOMNT #4	PAINT	PT.4	PT.1	PT.1	PT.4		VC 1	ACT 2		CPT 2	
218	OFFICE #14	PAINT	PT.1	PT.1	PT.4	PT.4		VC 1	ACT 2		CPT 2	
	OFFICE#13	PAINT	PT.4	PT.1	PT.1	PT4		VC 1	ACT 2		CPT 2	
	OFFICE #12	PAINT	PT.1	PT.1	PT.4	PT.4		VC 1	ACT 2		CPT 2	
	MED CONFERENCE	PAINT	PT.9	PT.9	PT.9	PT.9		VC 1	ACT 1	PT.1	CPT 2	
	SOUTH STAIR	PAINT	PT 2	PT.2	PT 2	PT 2		VC 1	PT 2		RB 1 RB 2	
	BREAK ROOM	PAINT	PT.8	PT.8	PT.8	PT 8		VC 1	ACT 2		LVT 1	
	OFF CE	PAINT	PT.1	PT.1	PT.1	PT.1		VC 1	ACT 2		LVT 1	
	OFFICE #7	PAINT	PT.7	PT7	PT.7	PT.7		VC 1	ACT 2		CPT 2	
	CORR	PAINT	PT.2	PT.2	PT 2	PT 2		VC 1	ACT 1	_	LVT 1	
	RR	PAINT	PT.3	PT.3	PT.3	PT3		VC 1	ACT 2	_	LVT 2	
	RR	PAINT	PT.3	PT.3	PT.3	PT.3		VC 1	ACT 2	_	LVT 2	
	CORRIDOR	PAINT	PT.2	PT 2	PT.2	PT 2		VC 1	ACT 1		LVI 2	
	OFFICE #1	PAINT	PT.4	PT.4	PT.1	PT.1		VC 1	ACT 2		CPT 2	
	OFFICE #2	PAINT	PT.1	PT.4	PT.4	PT.1		VC 1	ACT 2		CPT 2	
	COLLABORATION	PAINT	PT.2	PT 2	PT.2	PT2		VC 1	ACT 1		LVT 1	
	DEFICE #3	PAINT	PT.4	PT.4	PT.1	PT 1		VC 1	ACT 2		CPT 2	
	OFFICE #4	PAINT	PT.1	PT.4	PT.4	PT.1		VC 1	ACT 2		CPT 2	
			PT.4	PT4	PT.1	PT.1		VC 1			CPT 2	
	OFFICE #5	PAINT	PT.1	PT4	PT.4	PT.1		VC 1	ACT 2		CPT 2	
	CEO OFFICE											
	SML COMFERENCE	PAINT	PT.8	PT.8	PT.8	PT.8		VC 1	ACT 1		CPT 2	
	OFFICE #6	PAINT	PT.1	PT.1	PT.4	PT.4		VC 1	ACT 2		CPT 2	
	CORR	PAINT	PT.2	PT.2	PT.2	PT2		VC 1	ACT 1		LVT 1	
	OFFICE #8	PAINT	PT.7	PT.7	PT.7	PT.7		VC 1	ACT 2		CPT 2	
	PRODUCTION	PAINT	PT.7	PT.7	PT.7	PT.7		VC 1	ACT 2		CPT 2	
	OFFICE #9	PAINT	PT.7	PT.7	PT.7	PT.7		VC 1	ACT 2		CPT 2	
	OFFICE #10	PAINT	PT.7	PT.7	PT.7	PT.7		VC 1	ACT 2		CPT 2	
	OFFICE #11	PAINT	PT.7	PT.7	PT.7	PT.7		VC 1	ACT 2		CPT 2	
	BREAK	PAINT	PT.8	PT.8	PT.8	PT.8		VC 1	ACT 2		LVT 1	
	CLOSET	PAINT	PT.1	PT.1	PT.1	PT.1		VC 1	ACT 2		LVT 1	
	OFF CE	PAINT	PT.3	PT.3	PT.3	PT.3		VC 1	ACT 2		CPT 2	
	OFF CE	PAINT	PT.3	PT.3	PT.3	PT.3		VC 1	ACT 2		CPT 2	
	OFF CE	PAINT	PT.3	PT.3	PT.3	PT.3		VC 1	ACT 2		CPT 2	
	DFF CE	PAINT	PT.3	PT.3	PT.3	PT.3		VC 1	ACT 2		CPT 2	
251	OFF CE	PAINT	PT.3	PT.3	PT.3	PT.3		VC 1	ACT 2		CPT 2	

# PAINT LEGEND

PAINT	COLOR NAME	NUMBER	SHEEN	MANUFACTURER	SPECIFICATION
	TOQUE WHITE	SW 7003	SATIN	SHERWIN WILLIAMS	PROMAR 400 INTERIOR LATEX/EQUAL
	REPOSE GRAY	SW 7015	SATIN	SHERWIN WILLIAMS	PROMAR 400 INTERIOR LATEX/EQUAL
PT.3	DORIAN GRAY	SW 7017	SATIN	SHERWIN WILLIAMS	PROMAR 400 INTERIOR LATEX/EQUAL
PT.4	DOVETAIL	SW 7018	SATIN	SHERWIN WILLIAMS	PROMAR 400 INTERIOR LATEX/EQUAL
PT.5	GAUNTLET GRAY	SW 7019	SATIN	SHERWIN WILLIAMS	PROMAR 400 INTERIOR LATEX/EQUAL
PT.6	LOYAL BLUE	SW 6510	SATIN	SHERWIN WILLIAMS	PROMAR 400 INTERIOR LATEX/EQUAL
PT.7	MINDFUL GRAY	SW 7016	SATIN	SHERWIN WILLIAMS	PROMAR 400 INTERIOR LATEX/EQUAL
PT.8	KRYPTON	SW 6247	SATIN	SHERWIN WILLIAMS	PROMAR 400 INTERIOR LATEX/EQUAL
	LET IT RAIN	SW 9152	SATIN	SHERWIN WILLIAMS	PROMAR 400 INTERIOR LATEX/EQUAL
PT.10	BLACK FOX	SW 7020	SEMI-GLOSS	SHERWIN WILLIAMS	PROCLASSIC INTERIOR ACRYLIC LATEX ENAMEL/EQUAL
		NO	TE: BREAK ALL COLOR	TRANSITIONS ON INSIDE CO	RNERS

# FINISH LEGEND

RPET		
	ILOCATE	IPER SCHEDULE
	MANE.	MCHAWK GROUP, LEES
	STYLE NAME	TRANQUIL BEAUTY TILE 12 X 36
CPT 1	STYLE NUMBER	GT309
	COLOR NAME	PRIME
	COLOR NUMBER	837
	CONSTRUCTION	TUFTED, PATTERN TIP SHEAR, SOLUTION DYED
	LOCATE	PER SCHEDULE
	MANE.	MOHAWK GROUP, BIGELOW
	STYLE NAME	BENDING EARTH I, LATERAL SURFACE TILE
CPT 2	STYLE NUMBER	BT314
	COLOR NAME	LATERAL SURFACES
	COLOR NUMBER	7927
	CONSTRUCTION	TUFTED, TEXTURED PATTERN LOOP, SOLUTION DYED
E.		
	LOCATE	IPER SCHEDULE
	MANE/VENDOR	FLORIDA TILE
	PATTERN	TIME 2.0
TL 1	COLOR NAME	CARBON NATURAL
	COLOR NUMBER	FT/T28B
	SIZE	12/24
	GROUT	TEC 933 STANDARD GRAY
т		
	LOCATE	IPER PLANSFINSH SCHEDULE
	MANE.	MCHAWK GROUP
	STYLE	ANTIEK
LVT 1	COLOR NAME	ALABASTER
	COLOR NUMBER	311
	SIZE	9048
	THICKNESS	20 MIL WEAR LAYER, GLUE DOWN
	LOCATE	PER PLANSFINSH SCHEDULE
	MANE.	MOHAWK GROUP
LVT 2	STYLE COLOR NAME	MORIKATO SMOKE
LVI 2	COLOR NAME COLOR NUMBER	963
	SIZ#	7X4A
	THICKNESS	20 MIL WEAR LAYER, GLUE DOWN
	ITTOTALOO	
IBBER		STAIRIMAY
IBBER	LOCATE	STAIRWAY MODESAW
IBBER	LOCATE MANE.	MCHAWK
	LOCATE	MCHAWK MASTER STEP, RUBBER TILE, HAWMERED DISH
IBBER	LOCATE MANF. STYLE COLOR NAME	MOHAWK MASTER STEP, RUBBER TILE, HAMMERED DISH POLISHED PEWTER
	LOCATE MANF. STYLE	MCHAWK MASTER STEP, RUBBER TILE, HAWMERED DISH
	LOCATE MANF. STYLE COLOR NAME COLOR NAME	MOHAWK MASTER STEP, RUBBER TILE, HAMMERED DISH POLISHED PEWTER DS-1133
	LOCATE MANF. STYLE COLOR NAME COLOR NAME SIZE THICKNESS	MOTHAWK MASTER STEP, RUBBER TILE, HAWMERED DISH POLISHED PEW'ER BSH153 18 GAUGE
	LOCATE MANE STYLE COLOR NAME COLOR NAME SIZE THICKNESS	MCHANY MASTER STEP RUBBER TILE, HAMMERED DISH PCUSHED PEWIER DISH133 18X/18 18X/18 ISTRICTURE OF THE
	LOCATE MANF. STYLE COLOR NAME COLOR NAME SIZE THICKNESS LOCATE MANF.	IACHARY MASTER STEP RUBBER TILE HAVMERED DISH POLISHED PEWTER DS1133 18013 18010 180 GAUGE STAIN TREADSHISERS
	LOCATE MANF. STYLE COLOR NAME COLOR NAME SIZE THICKNESS LOCATE MANF. STYLE STYLE	ADDHAWN MANTER STEP, RUBBER TILE, HAMMERED DISH POLISED PEWTER STERRER STERRER STERRER STERRER STERRER MANTER MANT
RB 1	LOCATE MANF. STYLE COLOR NAME COLOR NAME SIZE THICKNESS LOCATE MANF. STYLE COLOR NAME COLOR NAME COLOR NAME COLOR NAME	MODERAND TO THE STEP FILESER TILE HAVMERED DISH MADERS THE FILESER TILE HAVMERED DISH MEDITED FOR THE STEP STEP STEP STEP STEP STEP STEP STE
RB 1	LOCATE MANF. STYLE COLOR NUMBER SUZE THICKNESS  LOCATE MANF. STYLE COLOR NUMBER COLOR NUMBER COLOR NUMBER COLOR NUMBER	MOHANK MATER STEP, RUSSER TILE, HAMMERED DESH PLU, GEOF DEWTER COLHTS)  198 OALUEE  198 OA
RB 1	LOCATE MANF. STYLE COLOR NAME COLOR NAME SIZE THICKNESS LOCATE MANF. STYLE COLOR NAME COLOR NAME COLOR NAME COLOR NAME	MODERAND TO THE STEP FILESER TILE HAVMERED DISH MADERS THE FILESER TILE HAVMERED DISH MEDITED FOR THE STEP STEP STEP STEP STEP STEP STEP STE
RB 1	LOCATE MANE STYLE COLOR NAME COLOR NAME COLOR NAME THICKNESS LOCATE MANE STYLE COLOR NAME	MOHANK MATER STEP, RUSSER TILE, HAMMERED DESH PLU, GEOF DEWTER COLHTS)  198 OALUEE  198 OA
RB 1	LOCATE MANF. STYLE COLOR NUMBER SUZE THICKNESS  LOCATE MANF. STYLE COLOR NUMBER COLOR NUMBER COLOR NUMBER COLOR NUMBER	MOHANK MATER STEP, RUSSER TILE, HAMMERED DESH PLU, GEOF DEWTER COLHTS)  198 OALUEE  198 OA
RB 1	LOCATE MANA: STYLE COLOR NAJME COLOR NAJME COLOR NAJME THICKNESS IZE THICKNESS TOTALE COLOR NAJME COLOR NAJME COLOR NAJME COLOR NAJME COLOR NAJME COLOR NAJME LOCATE LOCATE LOCATE LOCATE LOCATE MANAF. VENDOR	MOCHANIC MATTER TRESSET TILL FAMMERED DISH MATTER OTER FROM THE TEN AND THE T
RB 1	LOCATE MANF STYLE COLOR NAME COLOR NAME FICKINESS ILE LOCATE MANF STYLE COLOR NAME COLOR NAME COLOR NAME FICKINESS THICKNESS T	MOCHANIC MODER TILL MANAGERED DISH MOLTED STEP FROBER TILL MANAGERED DISH MOLTED STEP FROM THE MANAGERED DISH MOLTED STEP FROM THE MOLT
RB 1	LOCATE MANA: STYLE COLOR NAJME COLOR NAJME COLOR NAJME THICKNESS IZE THICKNESS TOTALE COLOR NAJME COLOR NAJME COLOR NAJME COLOR NAJME COLOR NAJME COLOR NAJME LOCATE LOCATE LOCATE LOCATE LOCATE MANAF. VENDOR	MOCHANIC MATERIALS PROGRAMMENT AMBERED DISH NAL WED PROFES .  MACHINE STEP FLORE .  150 GAUGE .  MACHINE STEP START TRADOS .  MACHINE START TRADOS .  MACHINE STEP START TRADOS .  MACHINE START TRADOS .  MACH
RB 1	LOCATE MANE STYLE COLOR NUMBER COLOR NUMBER SUZ DICKNESS LOCATE MANE STYLE COLOR NUMBER THCKNESS LOCATE MANE STYLE LOCATE MANE LOCATE MANE STYLE LOCATE MANE COLOR NUMBER THCKNESS STYLE COLOR NUMBER STYLE COLOR NUMBER THCKNESS STYLE COLOR NUMBER STYLE STYLE COLOR NUMBER SIZE	MOCHANIC MATTER TRUSTER TILL TAMBERED DISH MATTER OTER FROM THE TEN MA
RB 1	LOCATE MANA; STYLE COLOR NAJME COLOR NAJME COLOR NAJME THICKNESS LCCATE THICKNESS THICKNESS THICKNESS LCCATE LCCATE LCCATE LCCATE LCCATE LCCATE LCCATE LCCATE LCCATE COLOR NAJME	MOCHANIC MATERIALS PROGRAMMENT AMBERED DISH NAL WED PROFES .  MACHINE STEP FLORE .  150 GAUGE .  MACHINE STEP START TRADOS .  MACHINE START TRADOS .  MACHINE STEP START TRADOS .  MACHINE START TRADOS .  MACH
RB 1	LOCATE MANE STYLE COLOR NUMBER COLOR NUMBER SUZ THICKNESS LLOCATE MANE COLOR NUMBER THICKNESS LLOCATE MANE THICKNESS LLOCATE MANE COLOR NUMBER THICKNESS STYLE COLOR NUMBER THICKNESS	MOCHANIC MATTER TRUSTER TILL TAMBERED DISH MATTER OTER FROM THE TEN MA
RB 1	LOCATE  MANY  COLOR NAME  COLOR NAME  COLOR NAME  COLOR NAME  SIZE  THICKNESS  THOMAS  THICKNESS  LOCATE  MANY  COLOR NAME  THICKNESS  LOCATE  MANY  M	MOCHANIC MATTER TRUSTER THE TAXMERED DISH MATTER OTHER THE PROBER THE TAXMERED DISH MET AND THE TAXMERED DISH MET AND THE TAXMER THE
RB 1	LOCATE MANE STYLE COLOR NUMBER COLOR NUMBER SUZ THICKNESS LLOCATE MANE COLOR NUMBER THICKNESS LLOCATE MANE THICKNESS LLOCATE MANE COLOR NUMBER THICKNESS STYLE COLOR NUMBER THICKNESS	MOCHANIC MATERIAL PARAMETER DISH MATERIAL DISH MATERIAL PARAMETER DISH PARAMETER DIS
RB 1	LOCATE LEANF STYLE STYLE COLOR MUNEER COLOR MUNEER COLOR MUNEER SIZE THICKNESS LOCATE LAANF MANUE COLOR MUNEES THICKNESS LOCATE	MOCHANIC AND PROPERTY RUSSESS THE HAMMERED DISH MACHER STEP FROM THE HAMMERED DISH MACHER STEP FROM THE HAMMERED DISH MACHER STEP FROM THE HAMMER STEP FROM
RB 1	LOCATE IMANE STYLE STYLE COLOR NAJMER COLOR NAJMER THICKNESS LOCATE IMANE COLOR NAJMER THICKNESS LOCATE IMANE LOCATE IMANE LOCATE IMANE LOCATE IMANE LOCATE IMANE THICKNESS THICKNESS COLOR NAJMER THICKNESS THICKNESS THICKNESS THICKNESS COLOR NAJMER THICKNESS THICKNESS COLOR THICKNESS	MOCHANIC MATTER TRUBERT TILL TAMMERED DISH MATTER OTTER TRUBERT TILL TAMMERED DISH MATTER OTTER TRUBERT TILL TAMMERED DISH MATTER OTTER OT
RB 1	LOCATE MANY STYLE GOOGN MANE COCON MANE COCO	MOCHANIE AND PROPERTY TO ANABERED DISH MOCHTES TEEP RUSSER THE FAMILIER TO THE PROPERTY TO THE TOTAL PROPERTY THE TOTAL PROPERT
RB 1	LOCATE  JAMAF  STYLE  GOLOR NAME COLOR NAME JAMAF JAMA	MOCHANIC ADMINISTRATION AND ADMINISTRATION ADMINISTRATION AND ADMINISTRATION AND ADMINISTRATION ADMINISTRATION AND ADMINISTRATION ADMINISTRATION AND ADMINISTRATION
RB 1	LOCATE MANY STYLE GOOGN MANE COCON MANE COCO	MOCHANIE AND PROPERTY TO ANABERED DISH MOCHTES TEEP RUSSER THE FAMILIER TO THE PROPERTY TO THE TOTAL PROPERTY THE TOTAL PROPERT



PROJECT TITLE:

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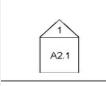
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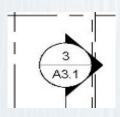
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DATE: 6 November 2015


# **Architectural Symbols**



**Elevations (Sheet A2.1, Elevation #1)** 



Sections (Sheet A3.1, Section #3)

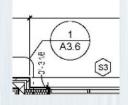


Details (Sheet A3.6, Detail #1)


# **Other Architectural Symbols**


- Interior Elevations
- Wall Types
- Door Types
- Window Types
- Miscellaneous Others




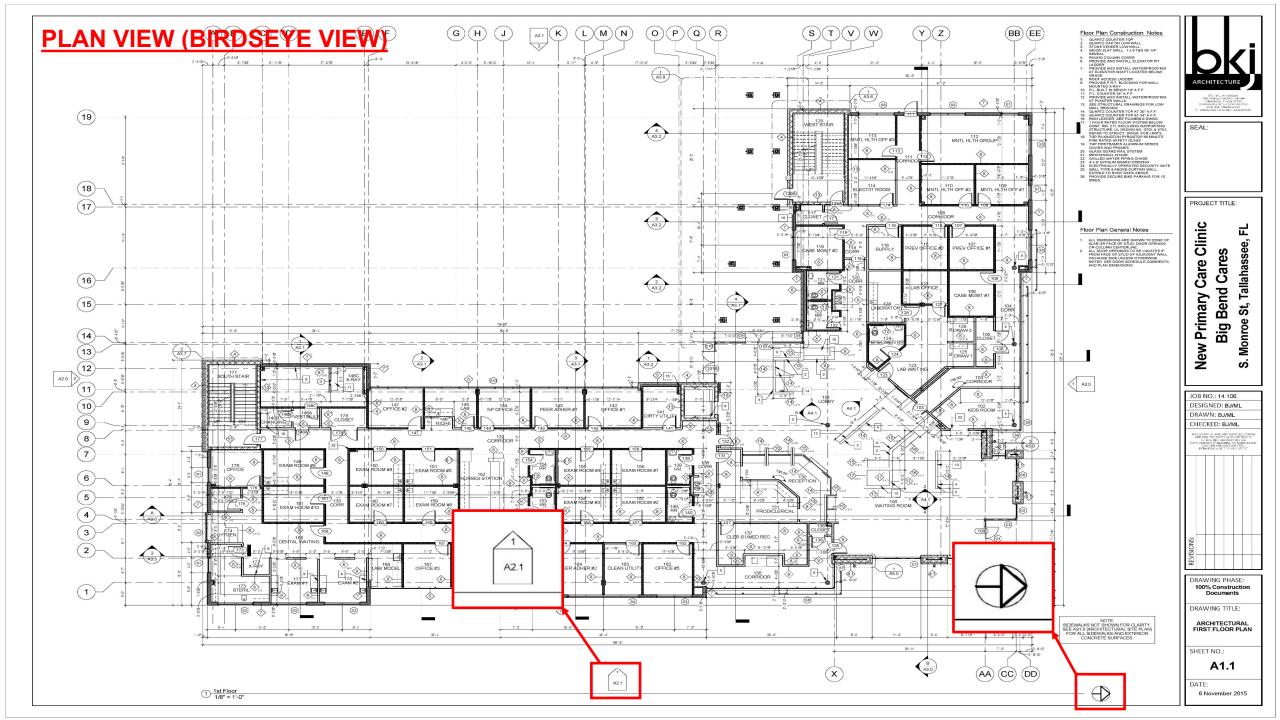



# **ELEVATIONS**

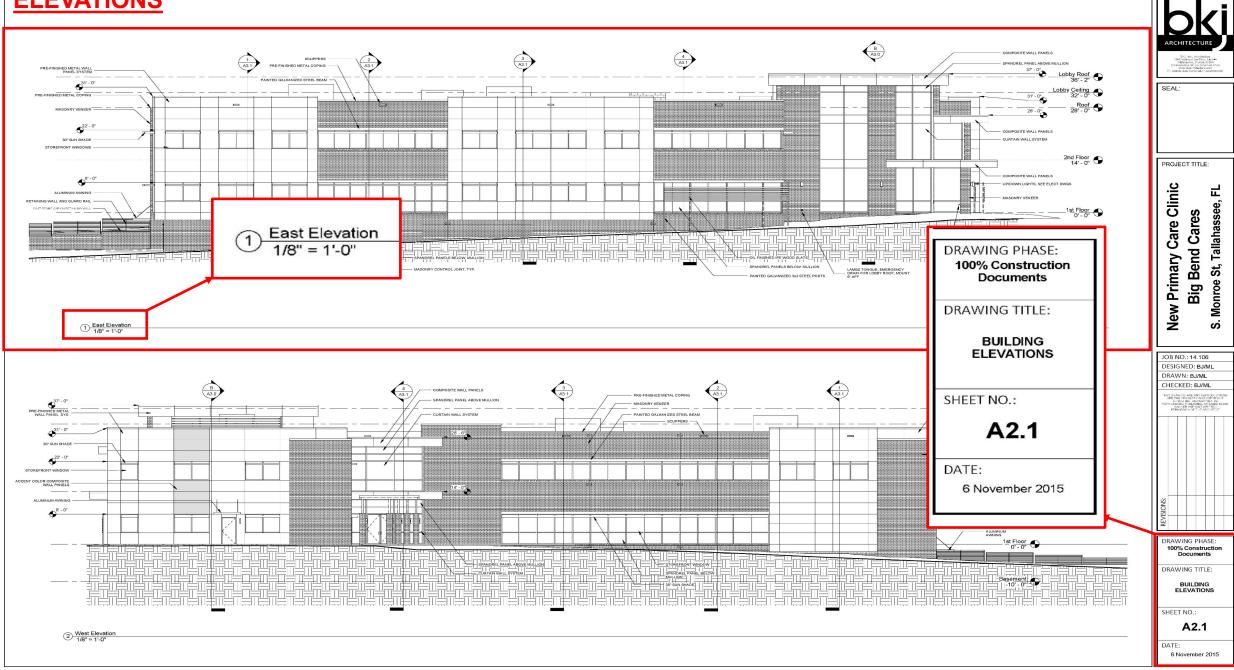


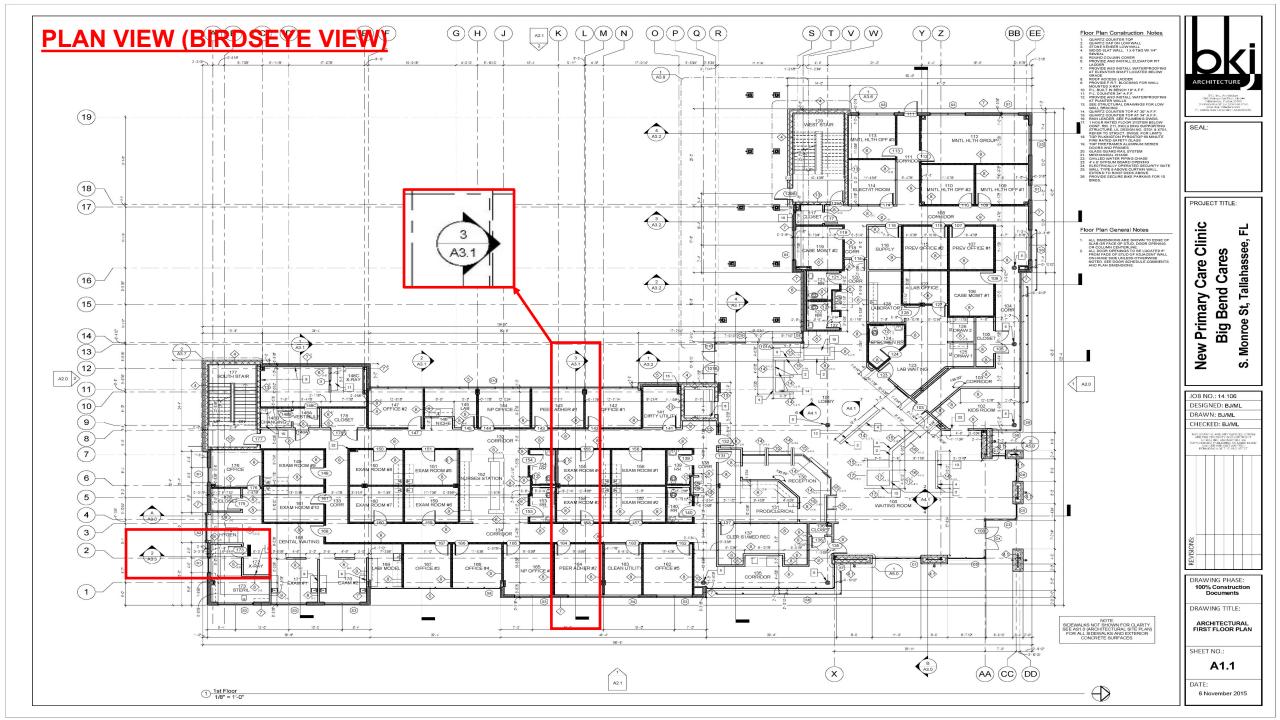

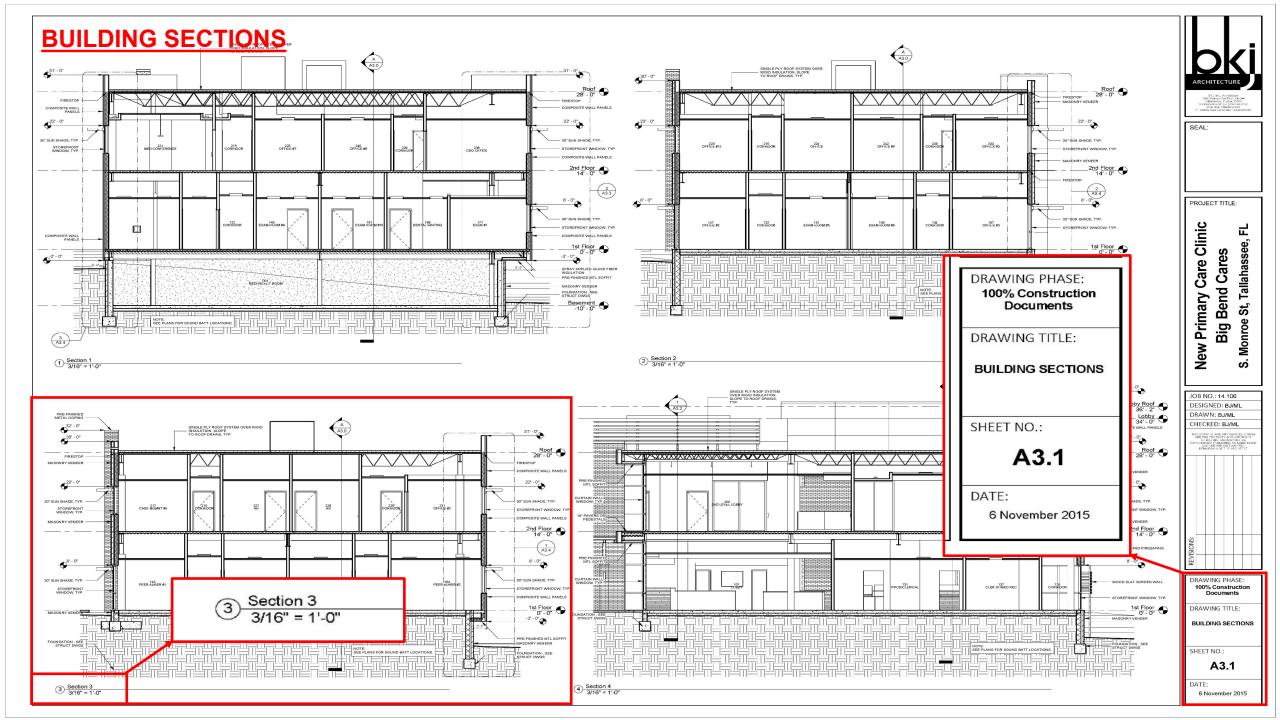

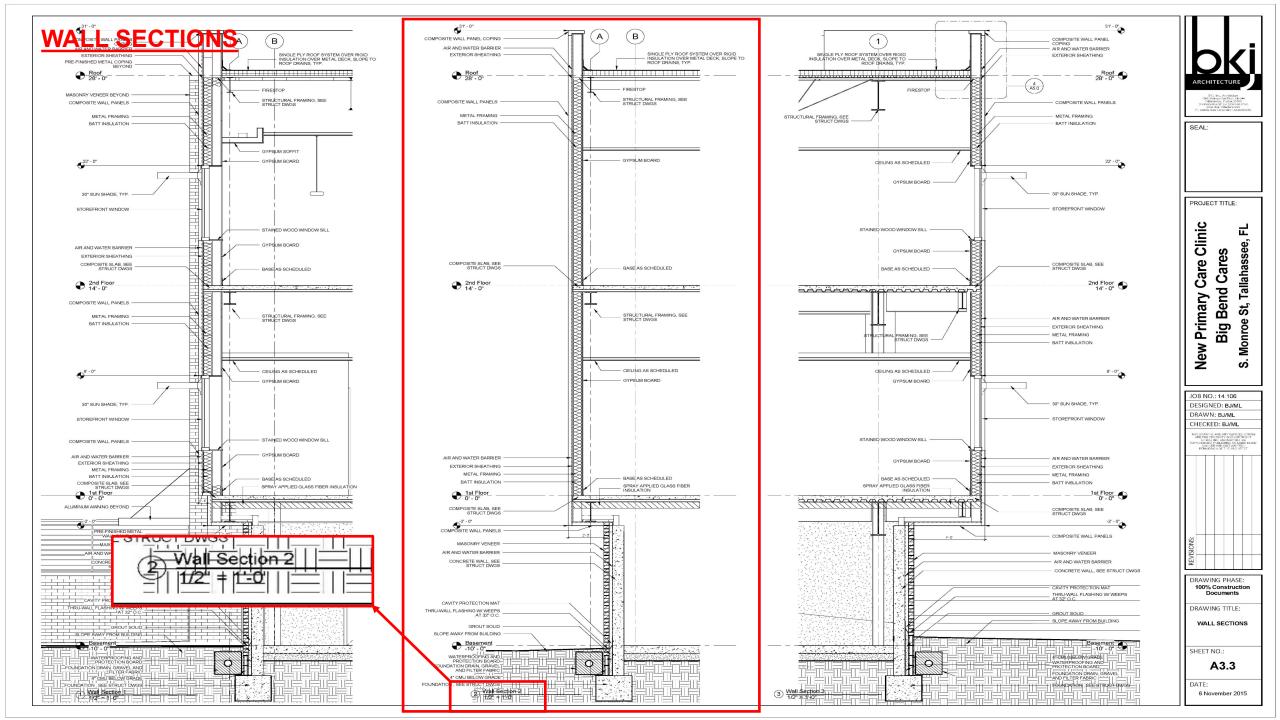

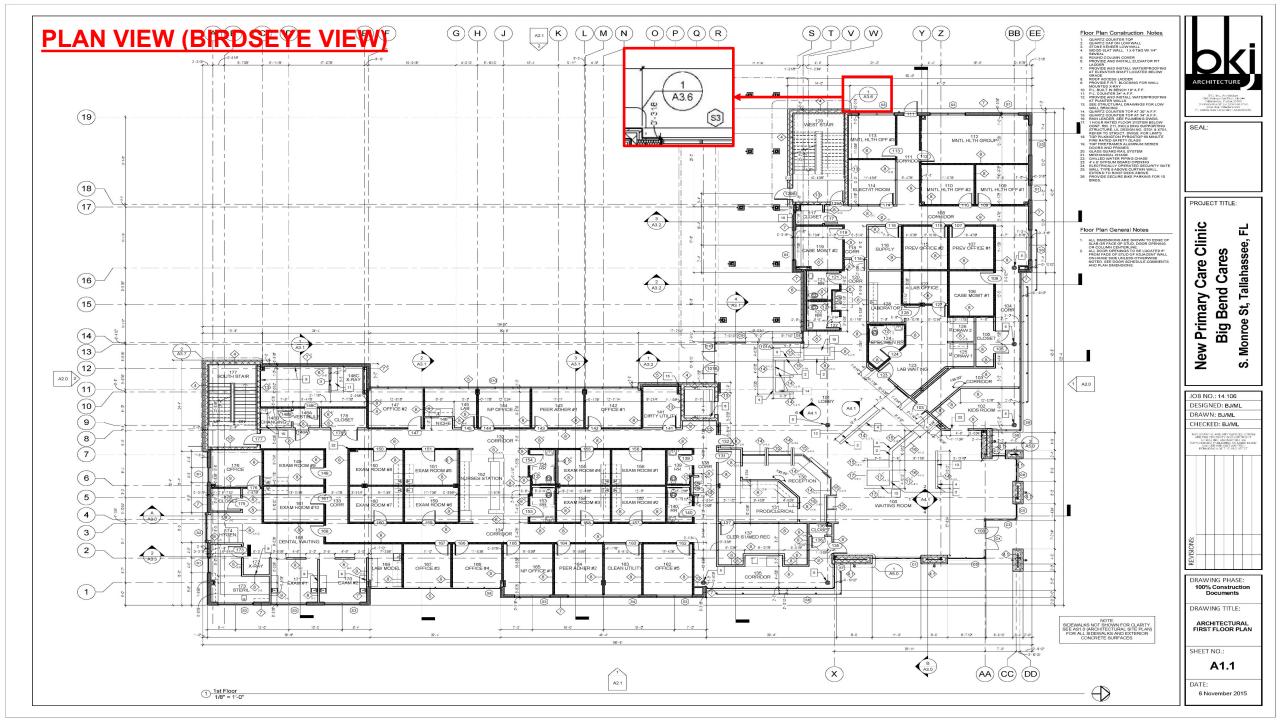

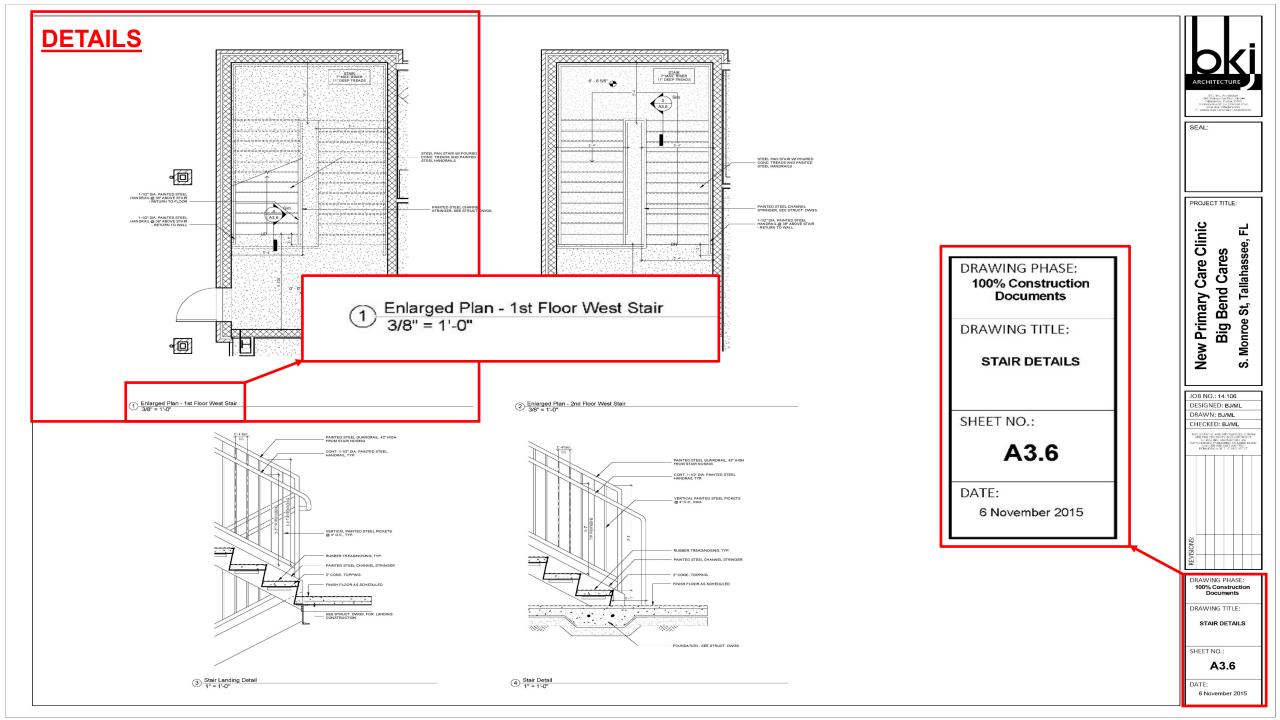

				WALLS				1			FLOOR	RING
	ROOM DESCRIPTION	FINISH	NORTH	EAST	SOUTH	WEST	NOTES	BASE	CEILING FINISH	SOFFIT	FLOOR FINISH	NOTES
GROUNE	DFLOOR											
001	MECH/ELECT ROOM	PAINT	PT.1	PT.1	PT.1	PT.1		VC 1			SEALED CONCRETE	
002	SOUTH STAIR	PAINT	PT.2	PT.2	PT.2	PT.2		VC 1	PT.2		RB 1	
FIRST FI												
100	WAITING ROOM	PAINT, STONE, WOOD	SEE FINISH PLAN	SEE FINISH PLAN	SEE FINISH PLAN	SEE FINISH PLAN		VC 1	WD 1	WD 1	CPT 1, LVT 1, TL 1	SEE FINISH PLAN
101	LOBBY	PAINT, STONE, WOOD	SEE FINISH PLAN	SEE FINISH PLAN	SEE FINISH PLAN	SEE FINISH PLAN		VC 1	ACT 1	PT.3/PT.5	CPT 1, LVT 1, TL 1	SEE FINISH PLAN
102	KIDS ROOM	PAINT	PT.3	PT.3	PT.3	PT.3		VC 1	ACT 2		CPT 1	
103	CORRIDOR	PAINT	PT.2	PT.2	PT.2	PT.2		VC 1	ACT 1		LVT 1	
104	CORR	PAINT	PT.2	PT.2	PT.2	PT.2		VC 1	ACT 1		LVT 1	
105	CLOSET	PAINT	PT.1	PT.1	PT.1	PT.1		VC 1	ACT 2		LVT 1	
106	CASE WGMT #1	PAINT	PT.7	PT.7	PT.7	PT.7		VC 1	ACT 2		CPT 2	
107	PREV OFFICE #1	PAINT	PT.7	PT.7	PT.7	PT.7		VC 1	ACT 2		CPT 2	
108	CORRIDOR	PAINT	PT.2	PT.2	PT.2	PT.2		VC 1	ACT 1		LVT 1	
109	MINTL HLTH OFF #1	PAINT	PT.8	PT.8	PT.8	PT.8		VC 1	ACT 2		CPT 2	
110	MINTL HLTH OFF #2	PAINT	PT.8	PT.8	PT.8	PT.8		VC 1	ACT 2		CPT 2	
111	CORRIDOR	PAINT	PT.2	PT.2	PT.2	PT.2		VC 1	ACT 1		LVT 1	
112	MINTL HLTH GROUP	PAINT	PT.9	PT.9	PT.9	PT.9		VC 1	ACT 2		CPT 2	
113	MINTL HLTH OFF #3	PAINT	PT.8	PT.8	PT.8	PT.8		VC 1	ACT 2		CPT 2	
114	ELECT/IT ROOM	PAINT	PT.1	PT.1	PT.1	PT.1		VC 1	ACT 2		LVT 1	
115	PREV OFFICE #2	PAINT	PT.7	PT.7	PT.7	PT.7		VC 1	ACT 2		CPT 2	
116	SUPPLY	PAINT	PT.1	PT.1	PT.1	PT.1		VC 1	ACT 2		LVT 1	
117	CLOSET	PAINT	PT.1	PT.1	PT.1	PT.1		VC 1	ACT 2		LVT 1	
118	CORR	PAINT	PT.2	PT.2	PT.2	PT.2		VC 1	ACT 1		LVT 1	
119	CASE VIGMT#2	PAINT	PT.7	PT.7	PT.7	PT.7		VC 1	ACT 2		CPT 2	
120	CORR	PAINT	PT.1	PT.1	PT.1	PT.1		VC 1	ACT 1		LVT 1	
121	RR	PAINT	PT.3	PT.3	PT.3	PT.3		VC 1	ACT 2		TL1	
122	RR	PAINT	PT.3	PT.3	PT.3	PT.3		VC 1	ACT 2		TL1	

				WALLS							FLOORII	NG
ROOM	ROOM DESCRIPTION	FINISH	NORTH	EAST	SOUTH	WEST	NOTES	BASE	CEILING	SOFFIT	FLOOR FINISH	NOTES
SECONE	FLOOR											
200	2ND LEVEL LOBBY	PAINT, STONE, WOOD	SEE FINISH PLAN	SEE FINISH PLAN	SEE FINISH PLAN	SEE FINISH PLAN		VC 1	ACT 1	PT.7	CPT 1, LVT 1	
201A	WAITING	PAINT	PT.2	PT.2	PT.2	PT.2		VC 1	ACT 1		CPT 1, LVT 1, LVT 2	
201B	PHARMACY	PAINT	PT.2	PT.2	PT.2	PT2		VC 1	ACT 2		LVT 1	
201C	PHAR, T	PAINT	PT.1	PT.1	PT.1	PT.1		VC 1	ACT 2		LVT 1	
202	PEER ADHER #2	PAINT	PT.8	PT.8	PT.8	PT.8		VC 1	ACT 2		CPT 2	
204	JANITOR	PAINT	PT.1	PT.1	PT.1	PT.1		VC 1	ACT 2		LVT 1	
205	CORRIDOR	PAINT	PT.1	PT.1	PT.1	PT.1		VC 1	ACT 1		LVT 1	
206	RR	PAINT	PT.3	PT.3	PT.3	PT.3		VC 1	ACT 2		LVT 2	
207	RR	PAINT	PT.3	PT.3	PT.3	PT.3		VC 1	ACT 2		LVT 2	
208	OPEN OFFICE	PAINT	PT.2	PT.2	PT.2	PT.2		VC1	ACT 2		GPT2	
209	RR	PAINT	PT.3	PT.3	PT.3	PT3		VC 1	ACT 2		LVT 2	
210	WEST STAIR	PAINT	PT.3	PT.3	PT.3	PT.3		VC 1	PT.2		RB 1, RB 2	
211	LRG CONF ROOM	PAINT	SEE FINISH PLAN	SEE FINISH PLAN	SEE FINISH PLAN	SEE FINISH PLAN		VC 1	ACT 1	PT.7	CPT 1	
212	ADMIN, ENTRY	PAINT	PT.2	PT.2	PT.2	PT2		VC 1	ACT 1		LVT 1	
213	ELECT. CLOSET	PAINT	PT.1	PT.1	PT.1	PT.1		VC 1	ACT 2		LVT 1	
214	CHAIR	PAINT	PT.1	PT.1	PT.1	PT.1		VC 1	ACT 2		CPT 1	
215	CORRIDOR	PAINT	PT.2	PT.2	PT.2	PT2		VC 1	ACT 1		LVT 1	
216	CASE MGMNT #3	PAINT	PT.1	PT.1	PT.4	PT.4		VC 1	ACT 2		CPT 2	
217	CASE MGMNT #4	PAINT	PT.4	PT.1	PT.1	PT.4		VC 1	ACT 2		CPT 2	
218	OFFICE #14	PAINT	PT.1	PT.1	PT.4	PT.4		VC 1	ACT 2		CPT 2	
219	OFFICE#13	PAINT	PT.4	PT.1	PT.1	PT.4		VC 1	ACT 2		CPT 2	
220	OFFICE #12	PAINT	PT.1	PT.1	PT.4	PT.4		VC 1	ACT 2		CPT 2	
221	MED CONFERENCE	PAINT	PT.9	PT.9	PT.9	PT.9		VC 1	ACT 1	PT.1	CPT 2	
222	SOUTH STAIR	PAINT	PT.2	PT.2	PT.2	PT2		VC 1	PT.2		RB 1, RB 2	
223	BREAK ROOM	PAINT	PT.8	PT.8	PT.8	PT8		VC 1	ACT 2		LVT 1	
224	OFF CE	PAINT	PT.1	PT.1	PT.1	PT.1		VC 1	ACT 2		LVT 1	
225	OFFICE #7	PAINT	PT.7	PT.7	PT.7	PT.7		VC 1	ACT 2		CPT 2	

NOTES

CEILING

FINISH

ACT 1

BASE

VC 1

SOFFIT

FINISH

FIN	ISH	LE	GΕ	ND

	LOCATE	PER SCHEDULE
	MANE.	MOHAWK GROUP, LEES
	STYLE NAME	TRANQUIL BEAUTY TILE 12 X 36
CPT 1	STYLE NUMBER	GT309
	COLOR NAME	PRIME
	COLOR NUMBER	837
	CONSTRUCTION	TUFTED, PATTERN TIP SHEAR, SOLUTION DYED
	LOCATE	PER SCHEDULE
	LOCATE MANE.	MOHAWK GROUP, BIGELOW
	MANF. STYLE NAME	
CPT 2	MANE.	MOHAWK GROUP, BIGELOW
CPT 2	MANF. STYLE NAME	MOHAWK GROUP, BIGELOW BENDING EARTH I, LATERAL SURFACE TILE
CPT 2	MANF. STYLE NAME STYLE NUMBER	MOHAWK GROUP, BIGELOW BENDING EARTH II, LATERAL SURFACE TILE BT314
CPT 2	MANF. STYLE NAME STYLE NUMBER COLOR NAME	MOHAWK GROUP, BIGELOW BENDING EARTH I, LATERA_SURFACE TILE BT314 LATERAL SURFACES

E.			
	LOCATE	PER SCHEDULE	
	MANE/VENDOR	FLORIDA TILE	
	PATTERN	TIME 2.0	
TL 1	COLOR NAME	CARBON NATURAL	
	COLOR NUMBER	FTIT28B	
	SIZE	123/24	
	GROUT	TEC 933 STANDARD GRAY	

	817=	9348
	COLOR NUMBER	311
LVT 1	COLOR NAME	ALABASTER
	STYLE	ANTIEK
	MANE.	MOHAWK GROUP
	LOCATE	PER PLANS/FINSH SCHEDULE

NOTES

FLOORING

FLOOR FINISH

CPT 2

											W	ALLS
				N	FI	INISH		NORTH			EAST	
1	236	CEO OFFICE			PA	INT			PT.	1	PT.4	
	UUKR RR	PAINI PAINT	PT3	P1.1	P1.3	P1.1		VC 1	ACT 2	LVI I		24
139	RR	PAINT	PT.3	PT.3	PT.3	PT.3		VC 1	ACT 2	LVT 2		240
141	DIRTY UTILITY	PAINT	PT.1	PT.1	PT.1	PT.1		VC 1	ACT 2	LVT 1		243
142	OFFICE #1	PAINT	PT.4	PT.4	PT.1	PT.1		VC 1	ACT 2	CPT 2		241
143	PEER ADHER #1	PAINT	PT.8	PT.8	PT.8	PT.8		VC 1	ACT 2	CPT 2		245
144	NP OFFICE #2	PAINT	PT.4	PT.4	PT.1	PT.1		VC 1	ACT 2	CPT 2		241
145	LAB	PAINT	PT.2	PT.2	PT.2	PT.2		VC 1	ACT 2	LVT 1		241
146	NICHE	PAINT	PT.3	PT.3	PT.3	PT.3		VC 1	PT.1	LVT 1		245
147	OFFICE #2	PAINT	PT.1	PT.1	PT.4	PT.4		VC 1	ACT 2	CPT 2		250
148A	VESTIBULE	PAINT	PT.8	PT.8	PT.8	PT.8		VC 1	ACT 2	LVT 1		25
148B 149C	CHANGING X-RAY	PAINT	PT.8 PT.8	PT.8 PT.8	PT.8 PT.8	PT.8 PT.8		VC 1	ACT 2 ACT 2	LVT 1		_
	-						PT. 18THORIZORTAL					
149	EXAM ROOM #9	PAINT	PT.1, PT.7	PT.1, PT.7	PT.1, PT.7	PT.1, PT.7	STRPE AT 36" AFF	VC 1	ACT 2	LVT 1		
150	EXAM ROOM 48	PAINT	PT.1, PT.7	PT.1, PT.7	PT.1, PT.7	PT.1, PT.7	STRPE AT INT APP	VC 1	ACT 2	LVT 1		
151	EXAM ROOM #5	PAINT	PT.1, PT.7	PT.1. PT.7	PT.1, PT.7	PT.1. PT.7	STREET AT INCHES	VC 1	ACT 2	LVT 1		
152	NURSES STATION	PAINT, WD 1	PT.3	PT.1	WD 1.PT.3	PT.1		VC 1	ACT 1	LVT 2		
153	RR	PAINT	PT.3	PT.3	PT.3	PT.3		VC 1	ACT 2	LVT 2		
154	RR	PAINT	PT.3	PT.3	PT.3	PT.3		VC 1	ACT 2	LVT 2		
155	EXAM ROOM #4	PAINT	PT.1, PT.7	PT.1, PT.7	PT.1, PT.7	PT.1, PT.7	STREET AT 34" AFT	VC 1	ACT 2	LVT 1		
156	EXAM ROOM ₹1	PAINT	PT.1, PT.7	PT.1, PT.7	PT.1, PT.7	PT.1, PT.7	STREE AT SIT APP	VC 1	ACT 2	LVT 1		
157	EXAM BOOM ₹2	PAINT	PT.1. PT.7	PT.1. PT.7	PT.1, PT.7	PT.1. PT.7	STREE AT SCIENCE	VC 1	ACT 2	DVT 1		
158	EXAM ROOM #3	PAINT	PT.1. PT.7	PT.1, PT.7	PT.1, PT.7	PT.1, PT.7	BIRTH AT HORIZONTAL BIRTH AT MY APP	VC 1	ACT 2	LVT 1		
159	EXAM ROOM #8	PAINT	PT.1, PT.7	PT.1, PT.7	PT.1, PT.7	PT.1, PT.7	PT 1 48 HORIZONTAL STRIPE AT 34" AFF	VC 1	ACT 2	LVT 1		
160	EXAM ROOM #/	PAINT	PT.1, PT.7	PT.1. PT.7	PT.1. PT.7	PT.1. PT.7	STREE AT 36" AFF	VC 1	ACT 2	LVT1		
161	EXAM ROOM #10	PAINT	PT.1, PT.7	PT.1, PT.7	PT.1, PT.7	PT.1, PT.7	STREE AT SHAPE	VC 1	ACT 2	LVT 1		
162	OFFICE #5	PAINT	PT.1	PT.4	PT.4	PT.1	22	VC 1	ACT 2	CPT 2		
163	CLEAN LITILITY	PAINT	PT.1	PT.1	PT.1	PT.1		VC 1	ACT 2	LVT 1		
164	PEER ADHER #2	PAINT	PT.8	PT.8	PT.8	PT.8		VC 1	ACT 2	CPT 2		
165	NP OFFICE #1	PAINT	PT.4	PT.4	PT.1	PT.1		VC 1	ACT 2	CPT 2		
166	OFFICE #4	PAINT	PT.4	PT,4	PT.1	PT.1		VC 1	ACT 2	CPT 2		
167	OFFICE #3	PAINT	PT.1	PT.4	PT.4	PT.1		VC 1	ACT 2	CPT 2		
168	DENTAL WAITING	PAINT		SEE FINISH PLAN	SEE FINISH PLAN	SEE FINISH PLAN		VC 1	ACT 2	CPT 1		
169	LAB/ MODEL	PAINT	PT.1	PT.1	PT.1	PT.1		VC 1	ACT 2	LVT 1		
170	EXAM #2	PAINT	SEE FINISH PLAN	SEE FINISH PLAN	SEE FINISH PLAN	SEE FINISH PLAN		VC 1	ACT 2	LVT1		
171	EXAM #1 X-RAY	PAINT PAINT	SEE FINISH PLAN	SEE FINISH PLAN	SEE FINISH PLAN	SEE FINISH PLAN		VC 1	ACT 2	LVT 1 CPT 1		
172	X-RAY exerci	PAINI	SEE FINISH PLAN	DEE FINISH PLAN	SEE FINISH PLAN	SEE FINISH PLAN		VC 1	ACT 2	CPTT		

OFFICE	PAINT	PT.3	PT.3	PT.3	PT.3	VC 1	ACT 2
OFFICE	PAINT	PT.3	PT.3	PT.3	PT3	VC 1	ACT 2
DFF CE	PAINT	PT.3	PT.3	PT.3	PT.3	VC 1	ACT 2
OFF CE	PAINT	PT.3	PT.3	PT.3	PT.3	VC 1	ACT 2
	INT LEGEI	NUMBER	SHEEN	MANUFACTURER		SPECIFICATIO	ON
			SHEEN SATIN	MANUFACTURER SHERWIN WILLIAMS	PROMAR 400 INTE		
PAINT PT.1	COLOR NAME	NUMBER			PROMAR 400 INTE	RIOR LATEX/EQUA	NL.
PAINT PT.1	COLOR NAME TOQUE WHITE	NUMBER SW 7003	SATIN	SHERWIN WILLIAMS		RIOR LATEX/EQUA	AL AL
PAINT PT.1 PT.2	COLOR NAME TOQUE WHITE REPOSE GRAY DORIAN GRAY	NUMBER SW 7003 SW 7015	SATIN SATIN	SHERWIN WILLIAMS SHERWIN WILLIAMS	PROMAR 400 INTE	RIOR LATEX/EQUA RIOR LATEX/EQUA RIOR LATEX/EQUA	AL AL
PAINT PT.1 PT.2 PT.3	COLOR NAME TOQUE WHITE REPOSE GRAY DORIAN GRAY DOVETAIL	NUMBER SW 7003 SW 7015 SW 7017	SATIN SATIN SATIN	SHERWIN WILLIAMS SHERWIN WILLIAMS SHERWIN WILLIAMS	PROMAR 400 INTE PROMAR 400 INTE	RIOR LATEX/EQUA RIOR LATEX/EQUA RIOR LATEX/EQUA RIOR LATEX/EQUA	AL AL AL
PAINT PT.1 PT.2 PT.3 PT.4 PT.5	COLOR NAME TOQUE WHITE REPOSE GRAY DORIAN GRAY DOVETAIL	NUMBER SW 7003 SW 7016 SW 7017 SW 7018	SATIN SATIN SATIN SATIN	SHERWIN WILLIAMS SHERWIN WILLIAMS SHERWIN WILLIAMS SHERWIN WILLIAMS	PROMAR 400 INTE PROMAR 400 INTE PROMAR 400 INTE	RIOR LATEX/EQUA RIOR LATEX/EQUA RIOR LATEX/EQUA RIOR LATEX/EQUA RIOR LATEX/EQUA	AL AL AL AL
PAINT PT.1 PT.2 PT.3 PT.4 PT.5	COLOR NAME TOQUE WHITE REPOSE GRAY DORIAN GRAY DOVETAIL GAUNTLET GRAY	NUMBER SW 7003 SW 7016 SW 7017 SW 7018 SW 7019	SATIN SATIN SATIN SATIN SATIN	SHERWIN WILLIAMS SHERWIN WILLIAMS SHERWIN WILLIAMS SHERWIN WILLIAMS SHERWIN WILLIAMS	PROMAR 400 INTE PROMAR 400 INTE PROMAR 400 INTE PROMAR 400 INTE	RIOR LATEXIEQUA RIOR LATEXIEQUA RIOR LATEXIEQUA RIOR LATEXIEQUA RIOR LATEXIEQUA RIOR LATEXIEQUA RIOR LATEXIEQUA	ML ML ML ML ML
PAINT PT.1 PT.2 PT.3 PT.4 PT.6 PT.6	COLOR NAME TOQUE WHITE REPOSE GRAY DORIAN GRAY DOVETALL GAUNTLET GRAY LOYAL BLUE MINDFUL GRAY	NUMBER SW 7003 SW 7016 SW 7017 SW 7018 SW 7019 SW 6510	SATIN SATIN SATIN SATIN SATIN SATIN	SHERWIN WILLIAMS SHERWIN WILLIAMS SHERWIN WILLIAMS SHERWIN WILLIAMS SHERWIN WILLIAMS SHERWIN WILLIAMS	PROMAR 420 INTE PROMAR 420 INTE PROMAR 420 INTE PROMAR 420 INTE PROMAR 420 INTE	RIOR LATEX/EQUA RIOR LATEX/EQUA RIOR LATEX/EQUA RIOR LATEX/EQUA RIOR LATEX/EQUA RIOR LATEX/EQUA RIOR LATEX/EQUA RIOR LATEX/EQUA	ML ML ML ML ML
PAINT PT.1 PT.2 PT.3 PT.4 PT.6 PT.6 PT.7	COLOR NAME TOQUE WHITE REPOSE GRAY DORIAN GRAY DOVETALL GAUNTLET GRAY LOYAL BLUE MINDFUL GRAY	NUMBER SW 7003 SW 7015 SW 7017 SW 7018 SW 7019 SW 8510 SW 7016	SATIN SATIN SATIN SATIN SATIN SATIN SATIN SATIN	SHERWIN WILLIAMS	PROMAR 400 INTE PROMAR 400 INTE PROMAR 400 INTE PROMAR 400 INTE PROMAR 400 INTE PROMAR 400 INTE	RIOR LATEX/EQUA RIOR LATEX/EQUA RIOR LATEX/EQUA RIOR LATEX/EQUA RIOR LATEX/EQUA RIOR LATEX/EQUA RIOR LATEX/EQUA RIOR LATEX/EQUA RIOR LATEX/EQUA	AL

WEST

PT.1

SOUTH

PT.4

RE Z	COLOR NAME	POLISHED PEWTER
	COLOR NUMBER	133
	THICKNESS	1/8 GAUGE
STONE		
ST 1	LOCATE	NA .
	MANE./VENDOR	ELDORADO STONE
	STYLE	LEDGECUT 33
	COLOR NAME	BIRCH
	SIZE	3" X 12-18-24", CORNER P ECES AVAILABLE
	THICKNESS	11/2"
EILING		
	LOCATE	PER PLANS
	MANE.	USG
	MATERIAL	ACT
ACT 1	COLOR NAME	WHITE
	COLOR NUMBER	NA NA
	STYLE	2X2X3/4* OLYMPIA MICRO 0.6 NRC, FLB (FINE LINE BEVEL)
	GRID	FINELINE DXF/DXLF, FLAT WHITE
	II SOURCE STATE	IDEO DI ANCI
	LOCATE MANE.	PER PLANS USG
	MATERIAL	ACT
1070	COLOR NAME	WHITE
ACT 2		NA NA
	COLOR NUMBER STYLE	2X2X3/4* OLYMPIA MICRO 0.6 NRC, SQ (SQUARE)
	GRID	DX/DXL, FLAT WHITE
	LOCATE	LOBBY
	MATERIAL.	SIPO MAHOGANY
WD 1	COLOR NAME	STAIN TO MATCH DOORS
	STYLE	T & G SQUARE EDGE, W/ 1/4* REVEAL
	STILL	W G SUCHNE EDGE, WITH REVENE
	LOCATE	RECEPTION DESK CURVATURA
CV 1	MANE.	ARVISTRONG
	MATERIAL	CURVATURA
	,	1
BASEBO	ARD	
	LOCATE	THROUGHOUT
	MANE.	BURKE FLOORING
VC 1	PROFILE	REPLICA
	SIZE	1,25
	COLOR	204 GRAY FOG
		•
VT TO	ARPET TRANSITION	STRIP
	LOCATE	THROUGHOUT
TR 1	MANE.	Schlüfer®-SCHIENE, Schlüfer®-RENO-TK (AS REQUIRED)
	COLOR	AE ANODIZED ALUMINUM
NTERIO	RDOORS	
	MANF.	MARSHFIELD DOOR SYSTEMS
		SIGNATURE SERIES WOOD VENEER DOORS
Di t	STYLE	
D 1	COLOR NAME	AFRICAN MAHOGANY, ESPRESSO
D1		
D1	COLOR NAME	AFRICAN MAHOGANY, ESPRESSO
	COLOR NAME CUT R DOOR HARDWARE	AFRICAN MAHOGANY, ESPRESSO FLAT CUT
	COLOR NAME CUT	AFRICAN MAHOGANY, ESPRESSO



SEAL:

PROJECT TITLE:

New Primary Care Clinic S. Monroe St, Tallahassee, FL **Big Bend Cares** 

JOB NO.: 14.106 DESIGNED: ML/CB DRAWN: ML/CB CHECKED: BJ/ML THIS DRAWNS AND ANY REPRODUCTION
AND THE PROPERTY AND COMPRISH
REPRODUCTO, PUBLISHED, OR LIBED IN A
MARKET PUBLISHED, OR LIBED IN A
MARKET PUBLISHED IN THE ARCHITECT

DRAWING PHASE: 100% Construction Documents

DRAWING TITLE:

FINISH SCHEDULE

SHEET NO.:

A6.0

6 November 2015

DATE:

# **Specifications**

- What are Construction Specifications?
- MasterFormat (50 Divisions)
  - Expanded From 16 to 50 Divisions in 2004
- Specification Sections
- What is included in each section?



# What Are Construction Specifications?

AIA A201 §1.1.6 defines Specifications as...

• "The portion of the Contract Documents consisting of the written requirements for materials, equipment, systems, standards and workmanship for the Work, and performance of related/services."

# **MasterFormat (50 Divisions)**

Specifications are organized by Divisions and subdivided

into Sections.

# **SPECIFICATIONS GROUP**

General Requirements Subgroup

Division 01 — General Requirements

Facility Construction Subgroup

- Division 02 Existing Conditions
- Division 03 Concrete
- Division 04 Masonry
- Division 05 Metals
- Division 06 Wood, Plastics, and Composites
- Division 07 Thermal and Moisture Protection
- Division 08 Openings
- Division 09 Finishes
- Division 10 Specialties
- Division 11 Equipment
- Division 12 Furnishings
- Division 13 Special Construction
- Division 14 Conveying Equipment

Facility Services Subgroup:


- Division 21 Fire Suppression
- Division 22 Plumbing
- Division 23 Heating, Ventilating, and Air Conditioning (HVAC)
- Division 25 Integrated Automation
- Division 26 Electrical
- Division 27 Communications
- Division 28 Electronic Safety and Security

Site and Infrastructure Subgroup:

- Division 31 Earthwork
- Division 32 Exterior Improvements
- Division 33 Utilities
- Division 34 Transportation
- Division 35 Waterway and Marine Construction

Process Equipment Subgroup:

- Division 40 Process Interconnections
- Division 41 Material Processing and Handling Equipment
- Division 42 Process Heating, Cooling, and Drying Equipment
- Division 43 Process Gas and Liquid Handling, Purification and Storage Equipment
- Division 44 Pollution and Waste Control Equipment
- Division 45 Industry-Specific Manufacturing Equipment
- Division 46 Water and Wastewater Equipment
- Division 48 Electrical Power Generation

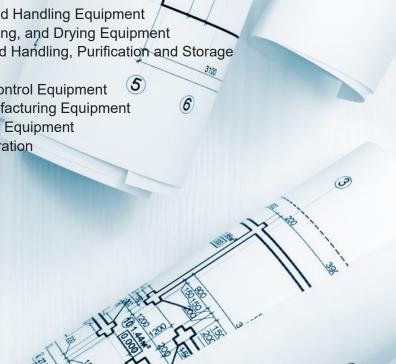

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# **Sections**

Submittal:

100% Construction Documents

BKJ Architecture Project No. 14.106 6 November 2015





# Big Bend Cares New Primary Care Clinic

Tallahassee Florida



BKJ, Inc. Architecture 1546 Metropolitan Blvd., Unit #4. Tallahassee, FL 32308 850.524.3701

FL Architecture Corp. AA26002280

Urban Catalyst Consultant 2840 Pablo Ave. Tallahassee, FL 32308 850.517.9906 FL CA 00030572

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Applied Research and Design, Inc. 3998 Bradfordville Rd., Ste B Tallahassee, FL 32309 850.524.1464 FL CA 8948

SheltonDean, Inc. SheltonDean Designs, LLC 2001 Thomasville Road Tallahassee, FL 32308 850.264.3559

Date issued:

Set No.

Big Bend Cares - New Primary Care Clinic

# DIVISION 07 - THERMAL AND MOISTURE PROTECTION

SECTION 071325 - SELF-ADHERING SHEET WATEPROOFING

SECTION 072100 - THERMAL INSULATION

SECTION 072726 - FLUID-APPLIED MEMBRANE AIR BARRIERS SECTION 074213.23 - METAL COMPOSITE MATERIAL WALL PANELS 0101

SECTION 075423 - THERMOPLASTIC POLYOLEFIN (TPO) ROOFING

SECTION 076200 - SHEET METAL FLASHING AND TRIM

SECTION 077200 - ROOF ACCESSORIES SECTION 078100 - APPLIED FIREPROOFING

SECTION 078413 - PENETRATION FIRESTOPPING

SECTION 079200 - JOINT SEALANTS

# **DIVISION 08 - OPENINGS**

SECTION 081113 - HOLLOW METAL DOORS AND FRAMES

SECTION 081416 - FLUSH WOOD DOORS

SECTION 083113 - ACCESS DOORS AND FRAMES

SECTION 084113 - ALUMINUM-FRAMED ENTRANCES AND STOREFRONTS

SECTION 084413 - GLAZED ALUMINUM CURTAIN WALLS

SECTION 087100 - DOOR HARDWARE SECTION 088000 - GLAZING

SECTION 088300 - MIRRORS

SECTION 088813 - FIRE-RESISTANT GLAZING

# **DIVISION 09 - FINISHES**

SECTION 092216 - NON-STRUCTURAL METAL FRAMING

SECTION 092900 - GYPSUM BOARD

SECTION 093000 - TILING

SECTION 095113 - ACOUSTICAL PANEL CEILINGS

SECTION 096513 - RESILIENT BASE AND ACCESSORIES

SECTION 096519 - RESILIENT FLOORING SECTION 096813 - TILE CARPETING

SECTION 099113 - EXTERIOR PAINTING

SECTION 099113 - EXTERIOR PAINTING

# **DIVISION 10 - SPECIALTIES**

SECTION 102600 - WALL AND DOOR PROTECTION

SECTION 102800 - TOILET, BATH, AND LAUNDRY ACCESSORIES

SECTION 104410 - FIRE-PROTECTION SPECIALTIES

SECTION 107113 - EXTERIOR SUN CONTROL DEVICES

SECTION 108213 - ROOF SCREENS

### **DIVISION 11 - EQUIPMENT**

SECTION 113100 - RESIDENTIAL APPLIANCES SECTION 115213 - PROJECTION SCREENS

BKJ 14.106

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# **Sections**

Big Bend Cares - New Primary Care Clinic

# DIVISION 07 - THERMAL AND MOISTURE PROTECTION

SECTION 071325 - SELF-ADHERING SHEET WATEPROOFING SECTION 072100 - THERMAL INSULATION SECTION 072726 - FLUID-APPLIED MEMBRANE AIR BARRIERS SECTION 074213.23 - METAL COMPOSITE MATERIAL WALL PANELS SECTION 075423 - THERMOPLASTIC POLYOLEFIN (TPO) ROOFING SECTION 076200 - SHEET METAL FLASHING AND TRIM SECTION 076200 - ROOF ACCESSORIES SECTION 078100 - APPLIED FIREPROOFING SECTION 078413 - PENETRATION FIRESTOPPING SECTION 079200 - JOINT SEALANTS

# **DIVISION 08 - OPENINGS**

SECTION 081113 - HOLLOW METAL DOORS AND FRAMES
SECTION 081416 - FLUSH WOOD DOORS
SECTION 083113 - ACCESS DOORS AND FRAMES
SECTION 083113 - ALUMINUM-FRAMED ENTRANCES AND STOREFRONTS
SECTION 084413 - GLAZED ALUMINUM CURTAIN WALLS
SECTION 084710 - DOOR HARDWARE
SECTION 088710 - POOR HARDWARE
SECTION 088000 - GLAZING
SECTION 088813 - FIRE-RESISTANT GLAZING

# DIVISION 09 - FINISHES

SECTION 092216 - NON-STRUCTURAL METAL FRAMING SECTION 09200 - GYPSUM BOARD SECTION 093000 - TILING SECTION 093000 - TILING SECTION 096113 - ACOUSTICAL PANEL CEILINGS SECTION 096613 - RESILIENT BASE AND ACCESSORIES SECTION 096813 - TILE CARPETING SECTION 096813 - TILE CARPETING SECTION 096123 - LIVERIOR DAINTING SECTION 099123 - INTERIOR PAINTING

# **DIVISION 10 - SPECIALTIES**

SECTION 102600 - WALL AND DOOR PROTECTION SECTION 102800 - TOILET, BATH, AND LAUNDRY ACCESSORIES SECTION 104410 - FIRE-PROTECTION SPECIALTIES SECTION 107113 - EXTERIOR SUN CONTROL DEVICES SECTION 108213 - ROOF SCREENS

### **DIVISION 11 - EQUIPMENT**

SECTION 113100 - RESIDENTIAL APPLIANCES SECTION 115213 - PROJECTION SCREENS Big Bend Cares - New Primary Care Clinic

SECTION 099123 - INTERIOR PAINTING

PART 1 - GENERAL

# 1.1 SUMMARY

- Section includes surface preparation and the application of paint systems on the following interior substrates:
  - Concrete masonry units (CMUs).
  - 2. Steel and iron.
  - Gypsum board.

# 1.2 DEFINITIONS

- MPI Gloss Level 1: Not more than five units at 60 degrees and 10 units at 85 degrees, according to ASTM D 523.
- B. MPI Gloss Level 2: Not more than 10 units at 60 degrees and 10 to 35 units at 85 degrees, according to ASTM D 523.
- C. MPI Gloss Level 3: 10 to 25 units at 60 degrees and 10 to 35 units at 85 degrees, according to ASTM D 523.
- D. MPI Gloss Level 4: 20 to 35 units at 60 degrees and not less than 35 units at 85 degrees, according to ASTM D 523.
- E. MPI Gloss Level 5: 35 to 70 units at 60 degrees, according to ASTM D 523.
- F. MPI Gloss Level 6: 70 to 85 units at 60 degrees, according to ASTM D 523.
- G. MPI Gloss Level 7: More than 85 units at 60 degrees, according to ASTM D 523.

# 1.3 ACTION SUBMITTALS

- Product Data: For each type of product. Include preparation requirements and application instructions.
  - Include Printout of current "MPI Approved Products List" for each product category specified, with the proposed product highlighted.
- B. Samples: For each type of paint system and in each color and gloss of topcoat.

BKJ 14.106 INTERIOR PAINTING 099123 - 1



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What is included in each section?

- Summary
- Definitions
- Submittal Requirements
- Quality Assurance (Mock-Ups)
- Products and Manufacturers
- Examination of Substrate
- Surface Preparation
- Application Procedures
- Schedule (Which products go where?)



# Order of Precedence

# Contract Clause

Not every contract defines the Order of Precedence, however in cases of inconsistency, conflict or ambiguity in the documents this clause will provide priority of documents.

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- 1. Change Orders / Amendments To The Contract
- 2. Contract between Owner and GC
- 3. Conditions of the Contract (General and Supplementary)
- 4. Architect Supplemental Instructions
- 5. Request For Information
- 6. Submittals / Shop Drawings (Approved by Architect)\*\*

- 7. Specifications
- 8. Details and Sections
- 9. Plan Drawings

Disclaimer: This is a general guideline. Project specific conditions may modify order of precedence

<sup>\*\*</sup> AIA 201 3.12.4 states "Shop Drawings.... Are not Contract Documents."

<sup>\*\*</sup> AIA 201 3.12.8 states "The work shall be in accordance with approved submittals except that the Contractor shall not be relieved of responsibility for deviations from the requirements of the Contract Documents..."

